
HEIGHTS

| TO: | Mayor Brennan and Members of City Council |
|-------|---|
| FROM: | Kelly M. Thomas, Clerk of Council |
| DATE: | August 11, 2023 |
| RE: | Planning Commission Decision |

At its regular meeting held on Thursday, August 3, 2023, the Planning Commission made the following motion to be approved by City Council.


A. Application from Drees Homes for the Demolition of Existing House Located at 2519 Claver (Homeowner: Friedman, Matis Mark & Shifra) for new house build. (Tabled at the July 6, 2023 meeting)

MOTION BY MAYOR BRENNAN, SECONDED BY MR. CASEY to Recommend to City Council the approval of the Application from Drees Homes for the demolition of the existing home located at 2519 Claver Road and for the approval of the Site Plan for the construction of the new home as submitted contingent on the lot coverage variance. On roll call, all voted "aye," except Mr. Reichek who "abstained".

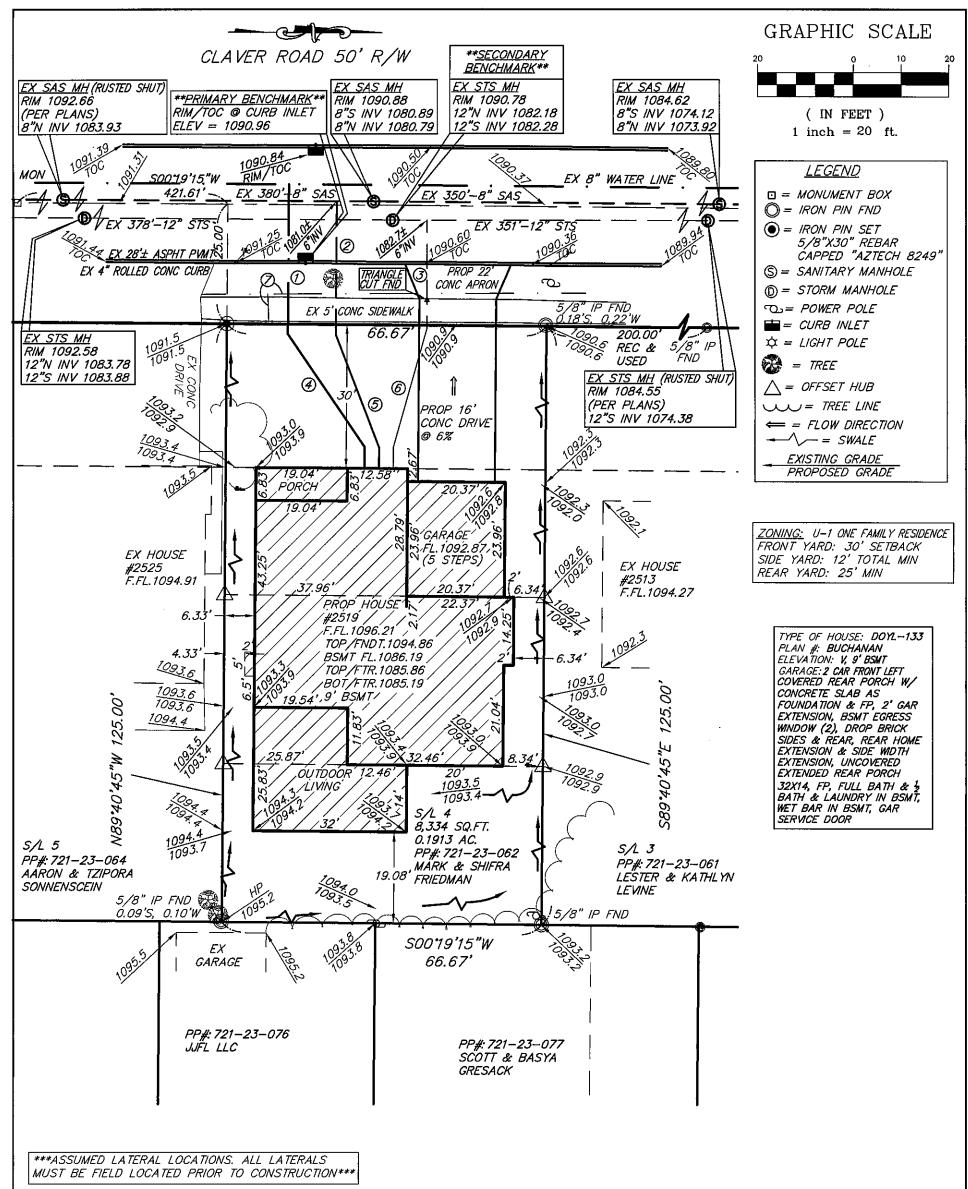

| (3) = EX STS LA (4) = PROP 1" T (5) = PROP 6" F (6) = PROP 6" F (7) = EX GAS LII BUILDER: CLEVEL 6650 W. S SUITE J, BRECKS | ONN AT - 6" INV = 1081.02 T - 6" INV = 1082.72 PVE 'K' COPPER WAT $PVC SDR 35 SAS CONN PVC SDR 35 STS CONN NE (MARKED BY OUPS) OUPS$ | E PLAT VOL.147, PG.32 CONN I @ 1% MIN O @ 1% MIN CO'S SUBDIVISION NO.25 PLAT VOL.96, PG.24 DATED: FEB, 1926 CITY OF UNIVERSITY HEIGHTS SEWER MAP | | | | |
|--|---|--|---|----------|-------------|----|
| HORIZ. SCALE: 1"=20' | VERT. SCALE: | 5425 WARNER ROAD - SUITE 12 VALLEY VIEW, OHIO 44125 440-602-9071 EAX 216-369-0259 | HOUSE LA YOUT FOR DREES HOMES - DOYL 133 | | | |
| | 7 40 40007 | | 2519 CLA VER ROAD KNOWN AS SUBLOT 4 IN THE | | | |
| DRAWN BY: JDC | DATE: 7/19/2023 | ATECH | I. DEUTCHMAN RESUBDIVISION | | | |
| CHECKED BY: SRL | DRAWING NO.: 20233898 | ENGINEERING + SURVEYING | PLAT VOL.147, PG.32 CITY OF UNIVERSITY HEIGHTS | | | |
| JOB NO.: 20233898 | SHEET: 1 OF 1 | Civil Engineering + Land Surveying | COUNTY OF CUYAHOGA. OHIO | NO. DATE | DESCRIPTION | BY |

| | | | | Finished Lower Level 2019 SF First Floor 2335 SF Second Floor 2225 SF Unfinished Areas Covered Front Porch 6579 SF Unfinished Areas Covered Front Porch 139 SF Garage 488 SF Outdoor Living 242 SF Unfinished Basement 326 SF Square Foologe told may vary by +1 SF due to automated rounding of first an Read raws Plan Review: 6/26/23 - REMOVE 2640 WINDOW AT GAME ROOM, ADD DBL 3050 - HORIZONTAL SIDING AT FRONT ELEVATION- REVISE ROOF LINE - REAR UNCOVERED PORCH - MIRROR POCKED DOOR - CLIP CORNER OF W.I.C. - WIDEN BASEMENT POWDER ROOM 12" - STRUCTURE ADDED PER REDLINES - 87 ALL SECOND FLOOR DOORS - GARAGE COACH LIGHTS - REMOVE CLG UIGHTS AT LIVING ROOM AND STUDY - RERWOYE CLG UIGHTS AT LIVING ROOM AND STUDY - RERWICE DOOR - REVISE FAMILY FOYER AND POWDER BATH LAYOUT - BRICK TO GRADE |
|---------------------------------------|--|--|-----------|--|
| | | | | Redraw per plan review: Delete transom and sidelight at front door and change door to Change front elevation vertical siding to shakes. Add pocket door at Recreation Roon hallway to bedrooms. Flip tub valve location at Both #5. Make Powder #2 bigger so the door can swing in. Add soffit at Living Room fireplace for vent. Add soffit at Living Room side windows to casement and re-center Change Breakfast Room siding glass doors to be single panel of Include extended concrete parch at rear per original study. Delete 2640 window at Butlers Pantry. Change (2)240 fixed at Kitchen to (2) 3060 casements. Add (2) 1260 fixed at Dining Room. Revise Tamily Foyer per redlines. Revise Owners Bath per redlines. Change Owners Bath per redlines. Delete Family Room beamed ceiling. Add pocket door to Bedroom #3/Bedroom #4 hallway. Reverse tub valve location at Bath #4 and Hall Bath shower. Add 3" to the width of the refridgerator wall by changing the per Add 3" to the width of the refridgerator wall by changing the per Add 3" to the width of the refridgerator wall by changing the per Add 3" to the width of the refridgerator wall by changing the per Add 3" to the width of the refridgerator wall by changing the per Add 3" to the width of the refridgerator wall by changing the per Add 3" to the width of the refridgerator wall by changing the per Add 3" to the width of the refridgerator wall by changing the per Add 3" to the width of the refridgerator wall by changing the per Add 3" to the width of the refridgerator wall by changing the per Add 3" to the width of the refridgerator wall by changing the per Add 3" to the width of the refridgerator wall by changing the per Add 3" to the width of the refridger |
| Architecture Plan Review: 🛛 No Commen | nts See Comments Items drawn on any drawings and | d not written in the contract selctions <u>WILL NOT</u> be included in the site specific drawing | | Customer Plan Review Signature |
| Customer Request: | Design Solution: | Reason For Modification: | Comments: | I understand that my new Drees home will be built in general co plans, specifications, selections and the Purchase Agreement, a |
| 1. XXX | 1. XXX | 1. XXX | 1. XXX | reviewed and approved. This set of plans may not reflect the ele for my house. Drees draws the standard plans complete with the options. The subcontractor's sets will show only the options I selec |
| 2. XXX | 2. XXX | 2. XXX | 2. XXX | selection sheets. I have reviewed the plot plan for my house and there may be some field adjustments as to the exact location of |
| 3. XXX | 3. XXX | 3. XXX | 3. XXX | Iot. I further understand that my home will not be built exactly like home or Model and that some minor variations from my plans ar may occur since every home that is built has it's own set of uniqu problems that must be dealt with as the home is being built. |
| 4. XXX | 4. XXX | 4. XXX | 4. XXX | Customer: Date: |
| | | | | Customer: Date: |

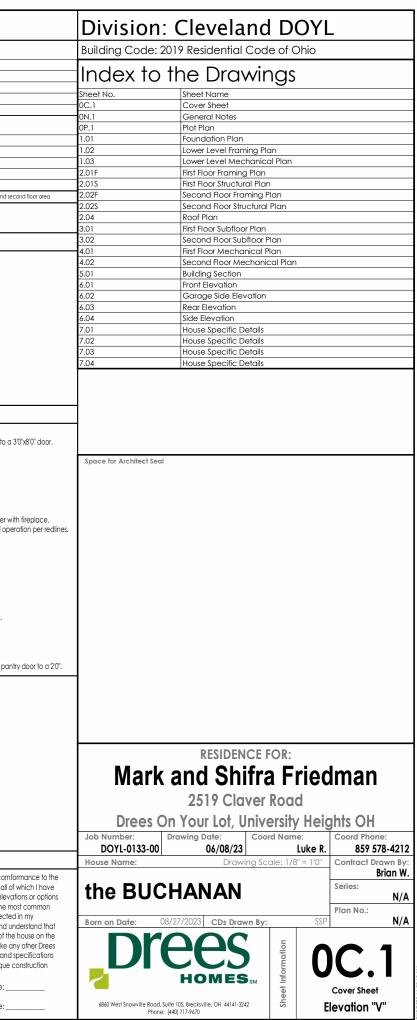


Square Footage

Living Areas

| GENERAL NOTES - CLEVELAND | |
|---|--|
| FOUNDATION NOTES | FRAMING NOTES |
| - ALL FOUNDATION WALLS TO BE 8" THICK POURED CONCRETE UNLESS OTHERWISE NOTED. - PROVIDE FOOTER DRAIN TILE ON OUTSIDE OF FOOTER TO SUMP PUMP OR TO DAYLIGHT. - BASEMENT WINDOW LOCATIONS MAY VARY FROM DRAWING DUE TO LOT CONDITIONS. - BACKFILL ADJACENT TO FOUNDATION WALLS SHALL NOT BE PLACED UNTIL THE WALL HAS SUFFICIENT STRENGTH AND HAS BEEN ANCHORED TO THE FLOOR OR HAS BEEN SUFFICIENTLY BRACED TO PREVENT DAMAGE BY THE BACKFILL. - WATERPROOF FOUNDATION WITH POLY MODIFIED ASPHALT SPRAY. - ASSUMED ALLOWABLE SOIL BEARING PRESSURE - 2,000 PSF - PROVIDE FOOTER DRAIN CLEANOUT 10' FROM BACK CORNER ON SIDE OF HOUSE OPPOSITE THE GARAGE. | -GUARDRAIL DESIGN LOAD TO RESIST A MINIMUM OF 200 LBS LATERAL FORCE. -ALL GLASS IN INTERIOR AND EXTERIOR DOORS TO BE TEMPERED (INCLUDING SIDELITES AND TRANSOMS). -IN THE GARAGE, PROVIDE 1/2" GYP. BOARD AT ALL WALLS COMMON TO LIVING SPACE AND ALL STRUCTURAL MEMBERS SUPPORTING FLOOR/CEILING ASSEMBLY. GARAGE CEILING TO BE 1/2" SAG RESISTANT GYP. BOARD WHEN THERE ARE N HABITABLE SPACES ABOVE. OR 5/8" TYPE X GYP. BOARD WHEN HABITABLE SPACES ARE ABOVE. -STAIRS IN LOWER LEVEL: IF THERE IS A DOOR INTO SPACE UNDER STAIR, THEN 1/2" GYP. BOARD REQ'D ON INSIDE OF STORAGE SPACE & UNDERSIDE OF STAIR IF THERE IS NO DOOR INTO SPACE -UNDER STAIR, IT IS CONSIDERED OPEN AND NO GYP. BOARD IS REQ'D. |
| - EXTERIOR FLATWORK AND GARAGE SLABS SHALL BE POURED WITH A MINIMUM CONCRETE STRENGTH OF 4,500 LBS. | MECHANICAL NOTES |
| VERTICAL CONTROL JOINTS IN BASEMENT FOUNDATION WALLS - STANDARD LOCATION GUIDELINES: PLACE A CONTROL JOINT IN ALL UNBRACED WALLS OVER 30' IN LENGTH. (NOTE: 'T'' WALLS AND CORNERS COUNT AS A BRACE). WINDOWS THAT ARE LARGER THAN THE STANDARD BASEMENT WINDOW REQUIRE A CONTROL JOINT. CONTROL JOINTS ARE NOT REQUIRED AT EVERY WINDOW THAT IS STANDARD SIZE. IF THERE IS A STANDARD WINDOW LOCATED IN A WALL SEGMENT THAT REQUIRES A CONTROL JOINT, THEN THE CONTROL JOINT SHOULD BE PLACED ON THE SIDE OF THE WINDOW THAT IS ADJACENT TO THE LONG SIDE OF THE WALL. IF THERE IS MORE THAN ONE WINDOW IN A WALL THEN ONLY ONE WINDOW SHOULD HAVE A CONTROL JOINT. DOORS DO NOT GET CONTROL JOINTS. CONTROL JOINTS SHOULD NOT BE LOCATED WITHIN 3' OF A BEAM POCKET. CONTROL JOINTS SHOULD NOT BE LOCATED WITHIN 3' OF A BEAM POCKET. CONTROL JOINTS ARE REQUIRED AT THE FIRST AND LAST STEP DOWN AT STEPPED BASEMENT FOUNDATION WALLS. OVERALL FOUNDATION WALL HEIGHT MAY VARY BY UP TO 1". GARAGE AND BASEMENT SLABS TO HAVE A MINIMUM 6 MIL. VAPOR BARRIER BETWEEN GRAVEL AND SLAB. INTERIOR FLATWORK SHALL HAVE A MINIMUM 6 MIL. VAPOR BARRIER BETWEEN GRAVEL AND SLAB. INTERIOR FLATWORK SHALL HAVE A MINIMUM CONCRETE STRENGTH OF 3,000 PSI. PLACE GARAGE SLAB CONTROL JOINTS PREPENDICULAR TO ONE ANOTHER, EACH STARTING FROM THE CENTERLINE OF GARAGE WALL. WHEN OVERDIG EXCEEDS 2'-0'', SLAB CONTROL JOINT SHOULD BE OFFSET FROM PILASTER 2-0' WITH ANOTHER, FACH STARTING FROM THE CENTERLINE OF GARAGE WALL. WHEN OVERDIG EXCEEDS 2'-0'', SLAB CONTROL JOINT SHOULD BE OFFSET FROM PILASTER 2-0' WITH ANOTHER JOINT RUNNING PERPENDICULAR. ALL VERTICAL STEEL AND ALL SLABS TO BE GRADE 60, ALL HORIZONTAL STEEL IN FOUNDATION WALLS AND FOOTERS TO BE GRADE 40 STEEL. | SMOKE DETECTORS TO BE 110V AND HARD WIRED. PROVIDE BATTERY BACK-UP AND INTERCONNECT (WHEN ONE SOUNDS, ALI SOUND). ALL GAS APPLIANCES MUST BE INSTALLED PER MANUFACTURER'S SPECIFICATIONS. A STAIR HANDRAIL, ON ONE SIDE ONLY, SHALL BE CONTINUOUS FOR THE ENTIRE LENGTH OF THE STAIRWAY, AND ENDS SHALL B RETURNED TO A WALL OR POST. THE HANDRAIL MAY BE INTERRUPTED AT A NEWEL POST AT A TURN. HANDRAIL SHALL BE INSTALLED ON ALL STARS WITH 3 OR MORE RISERS, HANDRAIL HEIGHT SHALL BE 34" MIN. / 38" MAX. ALL HANDRAIL GRIP PORTIONS SHALL NOT EXCEED 2 5/8" IN CROSS-SECTIONAL DIMENSION. KITCHEN BACKSPLASH OUTLETS TO BE LAID FLAT, 37-1/4" FROM TOP OF SUBFLOOR TO BOTTOM OF BOX. GUARDRAILS TO BE 36" (MIN.) HIGH. GUARDRAILS AT THE OPEN SIDES OF STAIRS TO BE 36" (MIN.) HIGH, MEASURED VERTICALLY RROM THE NOSING OF THE TREADS. THE HORIZONTAL SPACING OF THE VERTICAL BALUSTERS SHALL BE 4" O.C. GROUND FAULT CIRCUIT INTERRUPTER (GFCI) OUTLETS TO BE INSTALLED PER NEC 2017, SECT. 210.8; ADD TAMPER RESISTANT AN GFCI. ARC FAULT CIRCUIT OUTLETS TO BE INSTALLED PER NEC 2017, SECT. 210.8; OTHERWISE NOTED ON THE PROVIDE HOSE BIBS PER DIVISION SPEC. SHEET. EXACT LOCATION TO BE FIELD DETERMINED, UNLESS OTHERWISE NOTED ON THE RIME HOSE BIBS PER DIVISION SPEC. SHEET. EXACT LOCATION TO BE FIELD DETERMINED, UNLESS OTHERWISE NOTED ON THE RIME HOSE BIBS PER DIVISION SPEC. SHEET. EXACT LOCATION TO BE FIELD DETERMINED, UNLESS OTHERWISE NOTED ON THE RIME HOSE BIBS PER DIVISION SPEC. SHEET. EXACT LOCATION TO BE FIELD DETERMINED, UNLESS OTHERWISE NOTED ON THE RIME HOSE BIBS PER DIVISION SPEC. SHEET. EXACT LOCATION TO BE FIELD DETERMINED, UNLESS OTHERWISE NOTED ON THE RIME HOSE BIBS PER DIVISION SPEC. SHEET. EXACT LOCATION TO BE FIELD DETERMINED, UNLESS OTHERWISE NOTED ON THE RIME HOSE BIBS PER DIVISION SPEC. SHEET. EXACT LOCATION TO BE FIELD DETERMINED, UNLESS OTHERWISE NOTED ON THE RIME HOSE BIBS PER DIVISION SPEC. SHEET. EXACT LOCATION TO BE FIELD DETERMINED, UNLESS OTHERWISE NOTED O |
| FRAMING NOTES | PLANS. - MIN. 50 C.F.M. FOR ALL EXHAUST FANS IN BATHROOMS |
| PRAMING NOTES DESIGN LOADS: | - ALL HOUSES TO HAVE A PROGRAMMABLE THERMOSTAT. - TO COMPLY WITH SECTION 405 OF THE 2018 IECC (PERFORMANCE PATH). |
| Design LOADS: 40 pdf LIVE LOAD + 10 pdf DEAD LOAD = 50 pdf GARAGE FLOOR: 50 pdf LIVE LOAD + 20 pdf DEAD LOAD = 45 pdf WIND SPEED: 115 MPH DESIGN DEFLECTION LIWTS (BASED ON LIVE LOAD). EXCEPT MASONRY): RAFTERS GREATER THAN 3:12 LI/80 CELINIGS L/240 ASOMRY VENEER L/300 NOMINAL UNBER FLOORS: L/340 NOMINAL UNBER FLOORS: L/340 NOMINAL UNBER FLOORS: L/340 NOMINAL UNBER FLOORS: NOMO TO REVEAUATED. ADHERE TO THE FOLLOWING MINIMUM S: - L/480 (LIVE LOAD) FOR SPANS UP TO 16-0" AND NO GREATER THAN 1/2" DEFLECTION NO MORE THAN & POINT DIFFERENCE BETWEEN ADJACENT SPANS. * "IF PRO-RATING EQUIVALENCY CANNOT BE EVALUATED. ADHERE TO THE FOLLOWING MINIMUM S: - L/480 (LIVE LOAD) FOR SPANS UP TO 16-0" AND NO GREATER THAN 1/2" DEFLECTION - U/480 (LIVE LOAD) FOR SPANS UP TO 16-0" AND NO GREATER THAN 1/2" DEFLECTION - L/480 (LIVE LOAD) FOR SPANS UP TO 16-0" AND NO GREATER THAN 1/2" DEFLECTION - JOIST SPACING INSTALL UNCOUPLING MEMBRANE UNIT LEFLOOR RAREAST IF 12". Co.E. FLOOR JOIST SPACING GUE AND MECHANICALLY FASTEN (SCEWS) WOOD FLOOR IF 19.2" Co.E. FLOOR JOIST SPACING GUE AND MECHANICALLY FASTEN (SCEWS) WOOD FLOOR IF 19.2" Co.E. FLOOR JOIST SPACING GUE AND MECHANICALLY FASTEN (SCEWS) WOOD FLOOR IF 19.2" CO.E. FLOOR JOIST SPACING GUE AND MECHANICALLY FASTEN (SCEWS) WOOD FLOOR IF 19.2" Co.E. FLOOR JOIST SPA | - 10 COMPLY WITH SECTION 405 OF THE 2018 TECC (PERFORMANCE PATH). SECTION, DETAILS & ROOF PLAN NOTES - PRE-ENGINEERED WOOD TRUSSES @ 24" O.C. UNLESS NOTED OTHERWISE. - SEE TRUSS MANUFACTURER'S SHOP DRAWINGS FOR TRUSS LAYOUT AND DESIGN INCLUDING GIRDER TRUSSES AND BEAM LOCATIONS. - ALL GIRDER TRUSSES TO BE BOLTED TOGETHER ACCORDING TO MANUFACTURER'S SPECIFICATIONS. - TRUSSE MANUFACTURER'S DIMENSIONS ARE TO OUTSIDE OF SHEATHING. - ROOF TRUSS MANUFACTURER TO SPECIFY ALL CONNECTIONS AND HANGER'S ON SHOP DRAWINGS. - REFER TO HIB-91 OF TPI (TRUSS PLATE INSTITUTE) FOR SPECIFIC BRACING RECOMMENDATIONS AND REQUIREMENTS. - TRUSS MANUFACTURER TO SPECIFY ALL CONNECTIONS AND HANGER'S ON SHOP DRAWINGS. - REFER TO HIB-91 OF TPI (TRUSS PLATE INSTITUTE) FOR SPECIFIC BRACING RECOMMENDATIONS AND REQUIREMENTS. - TRUSS MANUFACTURER TO PROVIDE ENGINEERED TRUSS DRAWINGS TO THE FIELD ALONG W/ HIB-91 PRIOR TO ERECTION OF TRUSSES. - PROVIDE 147 #ELT PAPER UNDER SHINGLES - CONTRACTOR IS RESPONSIBLE FOR PROVIDING ALL TEMPORARY SHORING AND BRACING DURING CONSTRUCTION FOR ALL ELEMENTS INCLUDING WATER GUARD AT ALL EAVES AND VALLEYS. - ROOVIDE 154 #ELT PAPER UNDER SHINGLES - CONTRACTOR IS RESPONSIBLE FOR PROVIDING ALL TEMPORARY SHORING AND BRACING DURING CONSTRUCTION FOR ALL ELEMENTS INCLUDING WATER GUARD AT ALL EAVES AND VALLEYS. - ROOVIDE 164 PRUSSES WILL BE FASTENED BY CONNECTORS THAT WILL RESIST A MINIMUM OF 175 LBS OF UPLIFT - PROVIDE 7/16" ROOF SHEATHING. - INSTALLATION OF AN ICE BARRIER S REQUIRED. THE ICE BARRIER SHALL CONSIST OF NOT FEWER THAN TWO LAYERS OF UNDERLAYMENT AND EXTEND FROM THE LOWEST EDEGS OF ALL ROOF SURFACES TO A POINT NOT LESS THAN 24 INCH INSIDE THE EXTERIOR WALL INDERLAYMENT AND EXTEND FROM THE LOWEST EDEGS OF ALL ROOF SURFACES TO A POINT NOT LESS THAN 24 INCH INSIDE THE EXTERIOR WALL LINE OF THE BUILDING. THE 24 INCH MEASUREMENT SHALL BE ALONG THE SLOPE OF |
| SEE FIREPLACE ELEVATION DETAIL FOR ADDITIONAL FRAMING REQUIREMENTS, IF ANY, AND SEE SELECTION SHEET FOR SIZE AND STYLE OF FIREPLACE. PROVIDE BLOCKING AT ALL HANDRAIL BRACKETS, TOWEL BARS AND TOILET PAPER HOLDER LOCATIONS. PROVIDE 20 MIN. FIRE-RATED DOOR AT GARAGE/HOUSE ENTRY. PAD OUT GARAGE WALL CAVITIES/ FLOOR JOIST CAVITIES 3-1/2" TO RECEIVE FULL BATT INSULATION IF HEATING/ PLUMBING ARE PRESENT. FRAMING FOR HVAC CHASE TO EXTEND DOWN TO GARAGE SLAB. ALL BEARING WALLS TO HAVE DOUBLE TOP PLATE. A PARTIALLY EXPOSED EXTERIOR WALL, WALL SHEATHING SHOULD CONTINUOUSLY RUN TO BOTTOM OF SUB FLOOR. ALL IMBER CONTACTING CONCRETE TO BE PRESSURE TREATED. ALL FASTENERS, HANGERS, AND OTHER CONNECTORS TO BE USED WITH PRESSURE TREATED WOOD ARE TO HAVE ZMAX COATING (OR EQUIVALENT) HOT-DIPPED GALVANIZED OR STAINLESS STEEL. STAIR NOSING SHOULD BE 3/4" TO 1-1/4" MAX. STAIR TREADS ARE DIMENSIONED FROM NOSING TO NOSING, WITH A 9" MIN. TREAD. ALL EXTERIOR WALLS AND INTERIOR BEARING WALLS, FRAMED HIGHER THAN THE STD PLATE HEIGHT, SHALL BE FRAMED WITH CONTINUOUS FULL HEIGHT STUDS TO THE HIGHEST CEILING (I.E. NO INTERMEDIATE BREAKS) TO PREVENT LATERAL HINGE CONDITIONS. S76" (MIN.) OSB TO BE INSTALLED ON PORCH CEILINGS WHEN LIVING SPACE IS ABOVE. ALL ECRESS WINDOWS TO HAVE MINIMUM OPENING DIMENSIONS OF 24" IN HEIGHT, 20" IN WIDTH, AND HAVE A MINIMUM OPENING DIMENSIONS OF 24" IN HEIGHT, 20" IN WIDTH, AND HAVE A MINIMUM OPENING MEAN OF 54" OF 57.5.F ALL EGRESS WINDOWS TO BE A MAXIMUM OF 44" OFF OF FINISHED FLOOR. | ELEVATION NOTES - WINDOW STYLE AND MULLIONS MAY VARY FROM ELEVATION DEPENDING UPON MANUFACTURER, STYLE, PATTERN, TYPE, ETC FRONT DOOR COACH LIGHTS (IF ANY) TO BE SET AT 5'-8" ABOVE FINISHED SURFACE GRADE AWAY FROM FOUNDATION WALLS SHALL FALL A MINIMUM OF 6" WITHIN THE FIRST 10' PROVIDE BRICK WEEP HOLES WITH WEEP CARDS AT 24" o.c. WITH BRICK VENEER PROVIDE FLASHING AND WEEP HOLES AT 32" O.C. ABOVE BRICK ANGLE IRONS PROVIDE BRICK WALL TIES AT 16"o.c. HORIZONTALLY AND VERTICALLY. PROVIDE BRICK WALL TIES WITHIN 12" OF ANY BRICK OPENINGS AT A MAXIMUM OF 36" o.c. AROUND OPENING WRAP ALL FRIEZE AND FASCIA TRIM BOARDS IN ALUMINUM REFER TO DETAIL ON SHEET IN THE BUILDER BOOK FOR STONE INSTALLATION DETAILS PAD OUT ALL GABLE ENDS (WITHOUT GABLE EXTENSIONS) W/ (2) 1x3s PLACED SIDE BY SIDE WITH THE 1x8 OVER THE TOP TO COVER THE ENDS OF THE SIDING USE EXTERIOR PROTECTIVE COVERINGS ON ALL DIRECT VENT FIREPLACES (IF ANY) EXTERIOR STEPS TO HAVE A MAXIMUM 8" RISER. WHEN VERTICAL RISE EXCEEDS 30" OR FOUR OR MORE CONTINUOUS RISERS, A HANDRAIL IS REQUIRED. |
| | |

| ENO | 2019 RESIDENTIAL CODE OF OHIO METHOD USED FOR CHAPTER 11 ENERGY EFFICENCY OHBA PATH #2 (SECTION 1112) |
|----------------|--|
| ε | WALLS R VALUE R13 |
| | CEILINGS R VALUE R49 |
| ALL | WINDOWS U VALUE 32U |
| L BE | BASEMENT FOUNDTION WALLS R11 4 FT DOWN ALL WALLS |
| LY | FLOOR OVER UNCONDITIONED SPACE R30 |
| AND | RIM JOIST R13 |
| ΉE | INCLUDES ALL DESIGNATED MANDATORY CODE SECTIONS CHAPTER 11 |
| | |
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| | Space for Architect Seal |
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| DF | |
| CHES DM THE | |
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| | |
| С. | RESIDENCE FOR: Mark and Shifra Friedman |
| | 2519 Claver Road |
| | Drees On Your Lot, University Heights OH Job Number: Drawing Date: Coord Name: Coord Phone: |
| | DOYL-0133-00 06/08/23 Luke R. 859 578-4212 House Name: Drawing Scale: 1/8" = 1'0" Contract Drawn By: |
| , A | the BUCHANAN |
| | Born on Date: 08/27/2023 CDs Drawn By: SSP N/A |
| | |
| | Copyright © 2023 (2023) The Drees Company. All Rights Reserved. 6800 West Snowville Road, Suite 105, Brecksville, OH 44141-3242 |
| | Copyright © 2023 (2023) The Drees Company. All Rights Reserved. 6860 West Snowville Road, Suite 105, Brecksville, OH 44141-3242 Phone: [440] 717-9670 General Notes Elevation "V" |
| | |

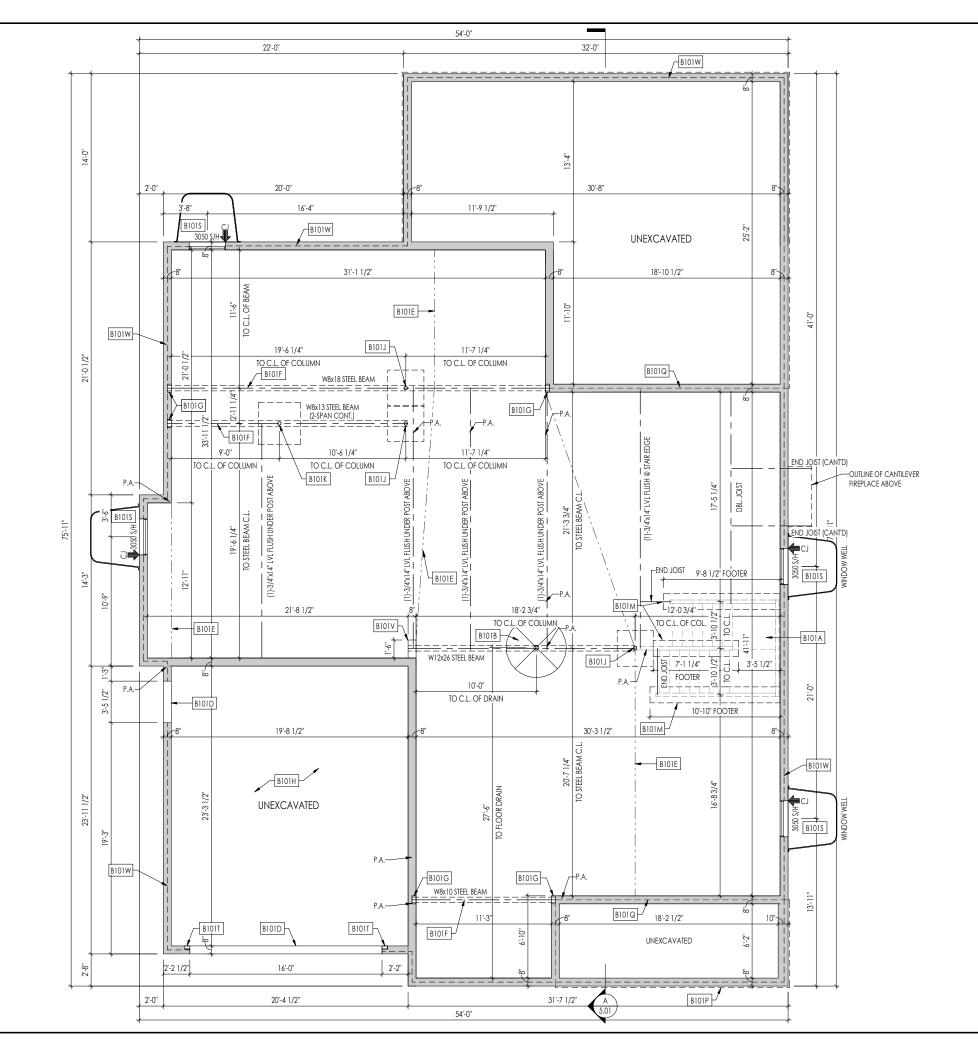

General Notes:

1. REFER TO SHEET ON.1 FOR GENERAL NOTES AND SHEET SD-0 FOR ENGINEERING NOTES.


- 2. ALL FOUNDATION WALLS TO BE 9-0" TALL AND 8" THICK UNLESS OTHERWISE NOTED. 3. OVERALL FOUNDATION WALL HEIGHT MAY VARY UP TO 1".
- 4. SEE SHEET ON.1 FOR VERTICAL FOUNDATION WALL CONTROL JOINT LOCATIONS.

Key Notes:


| Ke) | key notes: | | | |
|-------|--|--|--|--|
| B101A | OUTLINE OF BASEMENT STAIRS | | | |
| B101B | 5'-0" DIA. AREA SLOPED TO DRAIN - 2" LOWER THAN TOP OF SLAB | | | |
| B101D | CONTINUOUS FOOTING AND FOUNDATION - DROP TO BE FIELD DETERMINED | | | |
| B101E | SLAB CONTROL JOINT | | | |
| B101F | SLAB CONTROL JOINT LOCATED DIRECTLY UNDER STEEL BEAM | | | |
| B101G | 8"W x 8"H x 4"D BEAM POCKET | | | |
| B101H | RE: STANDARD DETAIL SHEET S-1A FOR GARAGE SLAB DETAILS | | | |
| B101J | STEEL COLUMN PER MANUFACTURER (12.0K MAX) ON 36"x36"x12" PLAIN CONCRETE PAD | | | |
| B101K | 3-1/2" DIA. ADJ. P.C. (18K CAP.) ON 42"x42"x12" FOOTING W/ #4 BARS @ 12" O.C. EA. WAY @ BOTTOM | | | |
| B101M | 8" DEEP x 16" WIDE THICKENED SLAB AT BEARING WALL | | | |
| B101P | 1-1/2" TYP. OVERHANG AT CONCRETE PORCH SLAB ABOVE - RE: SPECIFICATION MANUAL FOR FRONT PORCH CONSTRUCTION | | | |
| B101Q | OUTLINE OF STUD WALL / PORCH SLAB ABOVE | | | |
| B101S | LARGER BSMT WINDOW TO USE CONCRETE HEADER - BOTTOM OF WINDOW SILL 40" MAX. ABOVE FINISHED FLOOR AS REQ'D. FOR EGRESS | | | |
| B101T | PROVIDE 3"x 5-1/2" NOTCH FOR GARAGE DOOR TRACK - DROP TO BE FIELD DETERMINED TO CATCH GARAGE SLAB. RE: SPECIFICATION MANUAL FOR DETAILS | | | |
| B101V | DROP TOP OF FOUNDATION WALL 8" FOR STEEL BEAM SUPPORT | | | |
| B101W | DROPPED BRICK LEDGE AS REQUIRED - RE: DETAIL SHEET D1.1 (FIELD VERIFY EXACT LOCATIONS) | | | |
| | | | | |

Space for Architect Seal



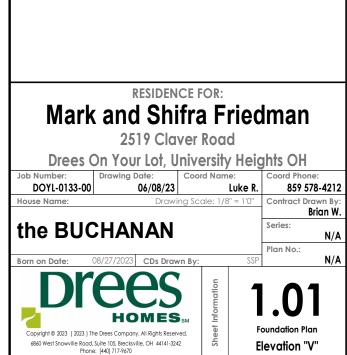

2 023 11:53:21 AI

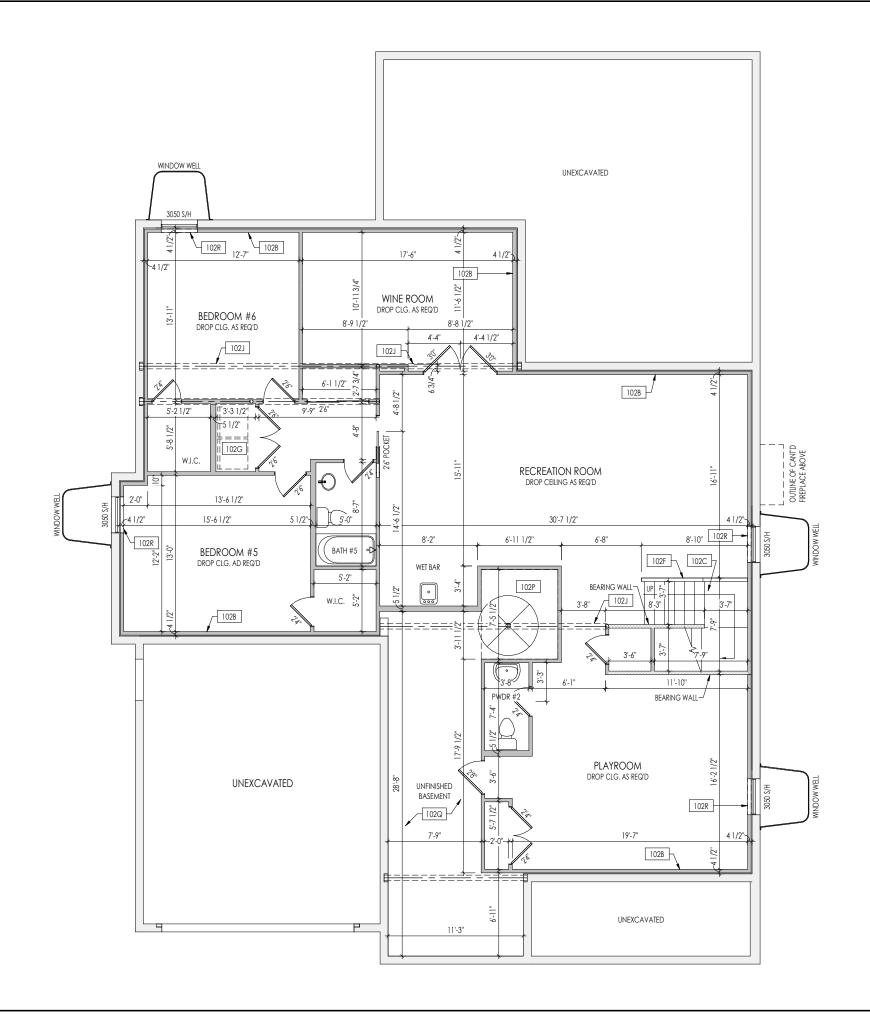


General Notes:


1. REFER TO SHEET ON.1 FOR GENERAL NOTES. 2. REFER TO SELECTION SHEETS FOR FLOORING MATERIAL PRIOR TO CONSTRUCTING STAIRS TO DETERMINE RISER HEIGHTS.


Key Notes:

| - / | |
|------|--|
| 102B | 2x4 STUDS HELD 1" FROM FOUNDATION WALL WITH 3-1/2" INSULATION |
| 102C | RE: DETAIL A/7.02 FOR BASEMENT STAIR FRAMING |
| 102F | SLOPE WALL EVEN WITH TOP OF STAIR STRINGER FOR RAILING |
| 102G | TAP AND DRAIN |
| 102J | BOX OUT AROUND COLUMNS AND BEAMS IN FINISHED AREA |
| 102P | 80 SQ. FT. MAX. AREA OF CEILING COMPLYING WITH EXCEPTIONS 3.1 + 3.2 NOT REQUIRING DRYWALL - PERIMETER EDGE MUST BE FIREBLOCKED TO KEEP SEPARATE FROM THE REST OF THE FLOOR ASSEMBLY |
| 102Q | UNFINISHED BASEMENT CEILING TO BE COVERED IN $1/2^{\prime\prime}$ GYPSUM BOARD (WITH THE EXCEPTION OF THE 80 SQ. FT. AREA) - JOINTS DO NOT NEED TO BE TAPED OR MUDDED |
| 102R | RIPPED 1x_ FOR WOOD SILL |




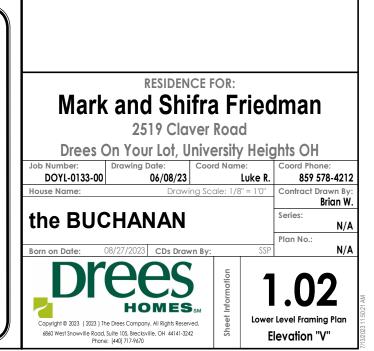

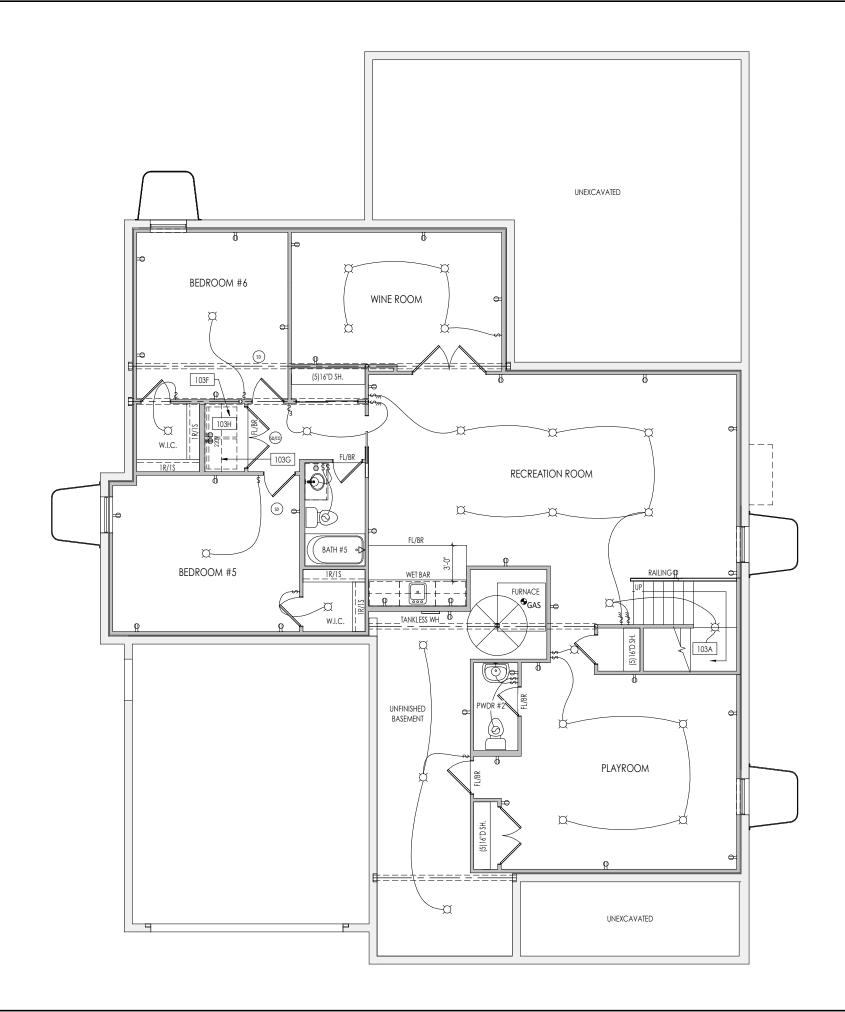

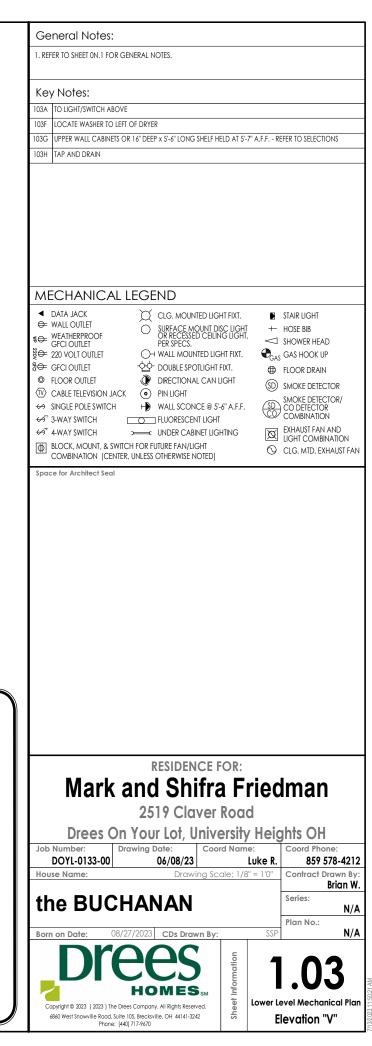

REISSUED: 07/13/2023

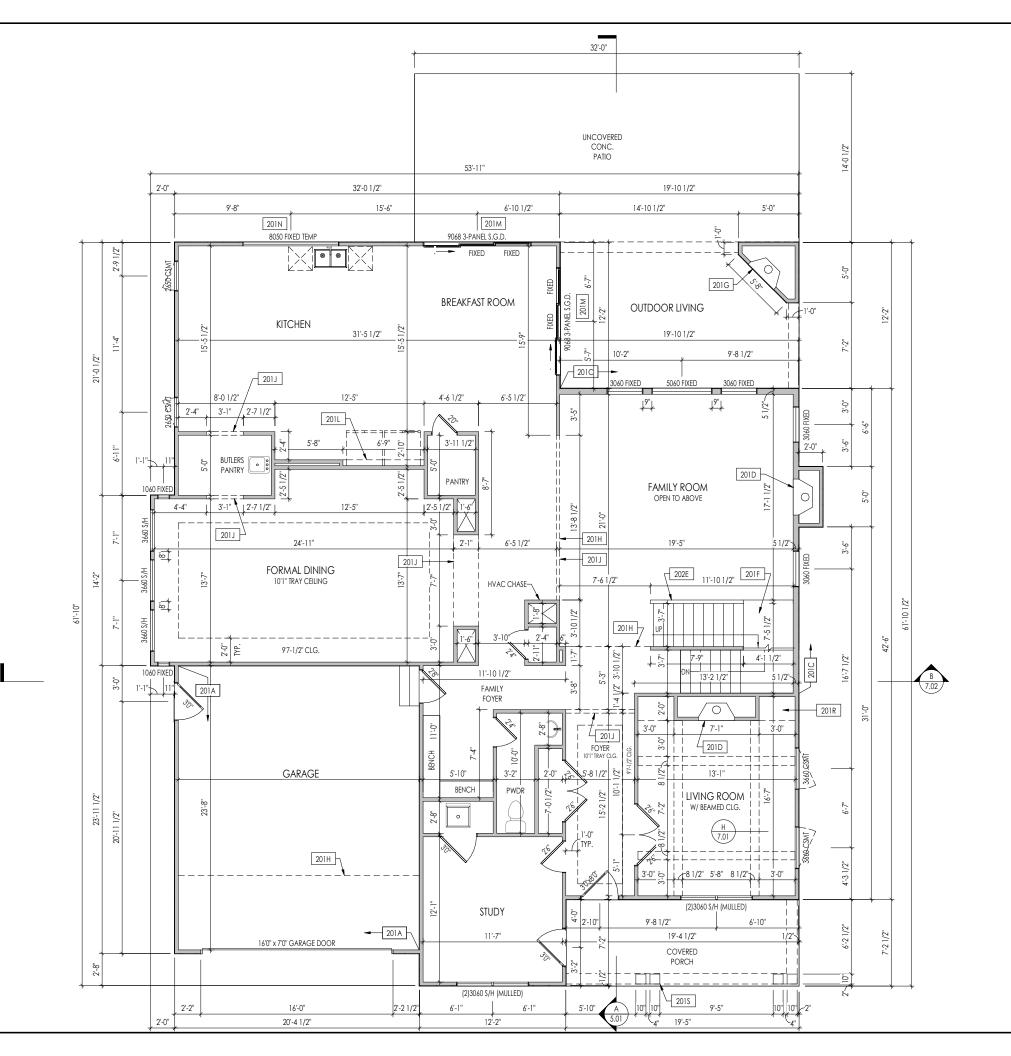


PROVIDE 8' TALL DOORS THROUGHOUT FIRST FLOOR


General Notes:

. REFER TO SHEET ON.1 FOR GENERAL NOTES. 2. ALL FIRST FLOOR CEILINGS TO BE 10-1" ABOVE SUBFLOOR UNLESS OTHERWISE NOTED. 3. FRAME TOP OF ALL WINDOWS AT 1'-10" BELOW TOP OF PLATE UNLESS OTHERWISE NOTED. 4. ALL DROPPED, INTERIOR HEADERS (FALSE AND BEARING) ARE DROPPED 1'-3" FROM CEILING. 5. REFER TO SELECTION SHEETS FOR FLOORING MATERIAL PRIOR TO CONSTRUCTING STAIRS TO DETERMINE RISER HEIGHTS. 6. ALL FIRST FLOOR EXTERIOR WALLS AND INTERIOR BEARING WALLS TO BE FRAMED AT 10'-1" HIGH WITH 2x4 STUDS @ 16" O.C. Key Notes: 201A FRAME GARAGE WALL AT 11'5-1/4" WITH (2)2x4 STUDS AT 16" O.C. FROM TOP OF FOUNDATION WAL - IF LECTRICAL PANEL LOCATED IN GARAGE PAD OUT WALL FOR ELECTRICAL PANEL 2x6 BALLOON FRAMED WALL - RE: SHEET 2.01S FOR FRAMING DID DIRECT VENT FIREPLACE - REFER TO SELECTION SHEET FOR MODEL AND FIREPLACE DETAIL SHEET F-1 FOR FRAMING INFORMATION


| 201F | RE: DETAIL A/7.02 FOR STAIR FRAMING |
|-------|---|
| 201G | DIRECT VENT FIREPLACE - REFER TO SELECTION SHEET FOR MODEL AND FIREPLACE DETAIL SHEET F-2 FOR FRAMING INFORMATION |
| 201H | OUTLINE OF SECOND FLOOR ABOVE |
| 201 J | FRAME TOP OF OPENING AT HEIGHT SPECIFIED IN GENERAL NOTES ON THIS SHEET |
| 201L | FRAME TOP OF OPENING AT REFRIGERATOR AT 6'-8" A.F.F. |
| 201M | (3)3010 FIXED (MULLED) ABOVE DOOR - TOP OF TRANSOM AT 1'0-1/4" BELOW TOP PLATE |
| 201N | FRAME TOP OF WINDOW AT TO X'-X" BELOW TOP PLATE |
| 201R | DROP TOP OF OPENING AS REQUIRED FOR DIRECT VENT FIREPLACE VENTING AND MATCH OPENING HEIGHT ON OTHER SIDE |
| 2015 | 10"x10" BOX COLUMN - RE: DETAIL B/7.01 FOR FRAMING |
| | |



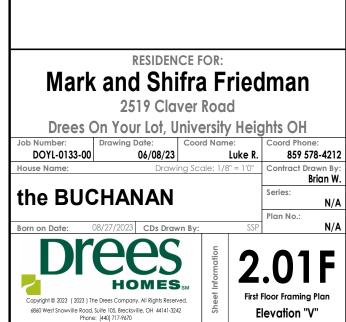

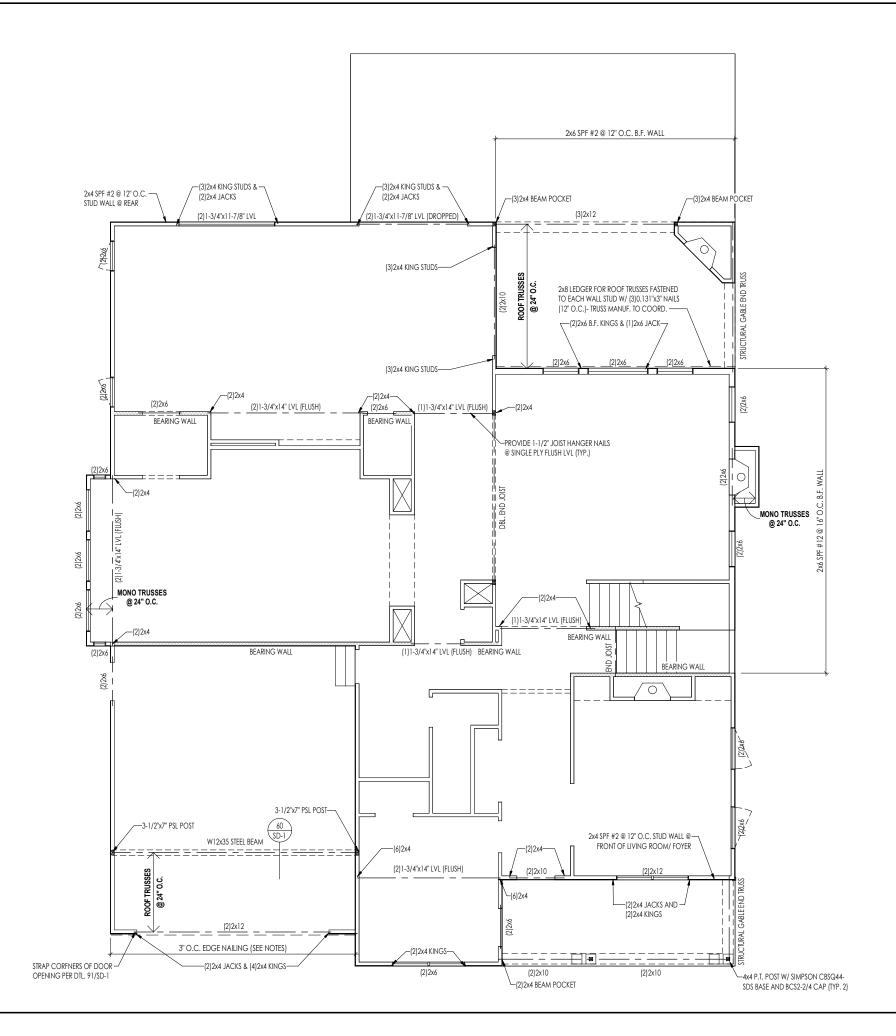

General Notes: . REFER TO SHEET S-0 FOR ENGINEERING NOTES. Key Notes: Space for Architect Seal 07/13/2023 **RESIDENCE FOR:** Mark and Shifra Friedman 2519 Claver Road Drees On Your Lot, University Heights OH • • Job Number: Drawina Date: Coord Name: Coord Phone REISSUED DOYL-0133-00 06/08/23 859 578-4212 Luke R. House Name: Drawing Scale: 1/8" = 1'0" Contract Drawn By Brian W the **BUCHANAN** Series: N/A Plan No.: N/A Born on Date: 08/27/20 CDs Drawn By HOMES First Floor Structural Plan Copyright © 2023 (2023) The Drees Company. All Rights Reserved. 6860 West Snowville Road, Suite 105, Brecksville, OH 44141-3242 Phone: [440] 717-9670 Elevation "V"

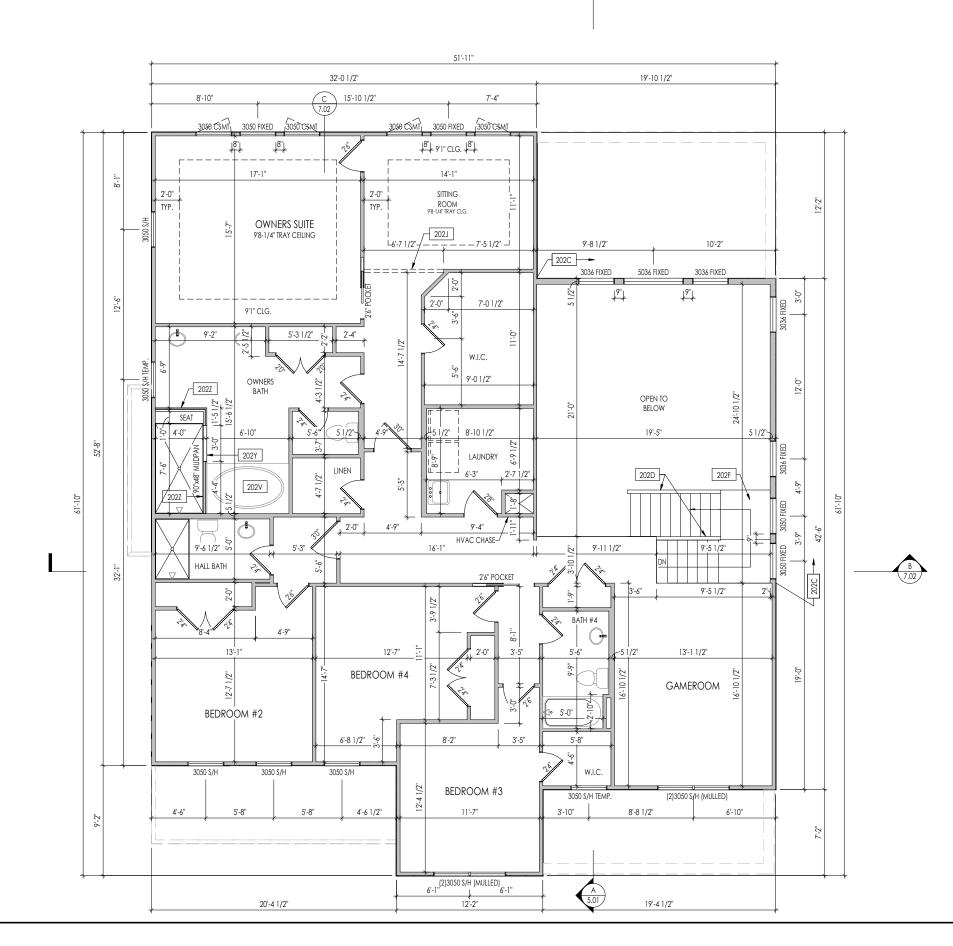

General Notes: PROVIDE 8' TALL DOORS THROUGHOUT FIRST FLOOR . REFER TO SHEET ON.1 FOR GENERAL NOTES. 2. ALL SECOND FLOOR CELINGS TO BE 9-1" ABOVE SUBFLOOR UNLESS OTHERWISE NOTED. 3. FRAME TOP OF ALL WINDOWS AT 1'-0 1/4" BELOW TOP OF PLATE UNLESS OTHERWISE NOTED. 4. ALL DROPPED, INTERIOR HEADERS (FALSE AND BEARING) ARE DROPPED 1'-0" FROM CEILING. REFER TO SELECTION SHEETS FOR FLOORING MATERIAL PRIOR TO CONSTRUCTING STAIRS TO DETERMINE RISER HEIGHTS. Key Notes: 202C 2x6 BALLOON FRAMED WALL - RE: SHEET 2.02S FOR FRAMING 202D RAILING- SLOPE WALL WITH STAIR STRINGER 202F RE: DETAIL A/7.02 FOR STAIR FRAMING DETAILS 202J FRAME TOP OF OPENING AT HEIGHT SPECIFIED IN GENERAL NOTES ON THIS SHEET 202V RE: DETAIL B/7.02 FOR TUB PLATFORM FRAMING PROVIDE 4-1/2" SHOWER CURB 202Y 202Z 36" HIGH WALL WITH SHOWER GLASS ABOVE Space for Architect Seal 07/13/2023 **RESIDENCE FOR:** Mark and Shifra Friedman 2519 Claver Road Drees On Your Lot, University Heights OH • • Job Number: Drawina Date: Coord Phone Coord Name REISSUED DOYL-0133-00 06/08/23 859 578-4212 Luke R. Drawing Scale: 1/8" = 1'0" Contract Drawn By House Name: the **BUCHANAN** Series: Plan No.: Born on Date: CDs Drawn By

HOMES

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Second Floor Framing Plan Elevation "V"


Brian W

N/A

N/A



General Notes: . REFER TO SHEET S-0 FOR ENGINEERING NOTES. Key Notes: Space for Architect Seal 07/13/2023 **RESIDENCE FOR:** Mark and Shifra Friedman 2519 Claver Road Drees On Your Lot, University Heights OH **REISSUED:** Job Number: Drawing Date: Coord Name: Coord Phone: DOYL-0133-00 06/08/23 859 578-4212 Luke R. House Name: Drawing Scale: 1/8" = 1'0" Contract Drawn By Brian W the **BUCHANAN** Series: N/A Plan No.: N/A Born on Date: 08/27/20 CDs Drawn By HOMES Second Floor Structural Plan Copyright © 2023 (2023) The Drees Company. All Rights Reserved. 6860 West Snowville Road, Suite 105, Brecksville, OH 44141-3242 Phone: [440] 717-9670 Elevation "V"

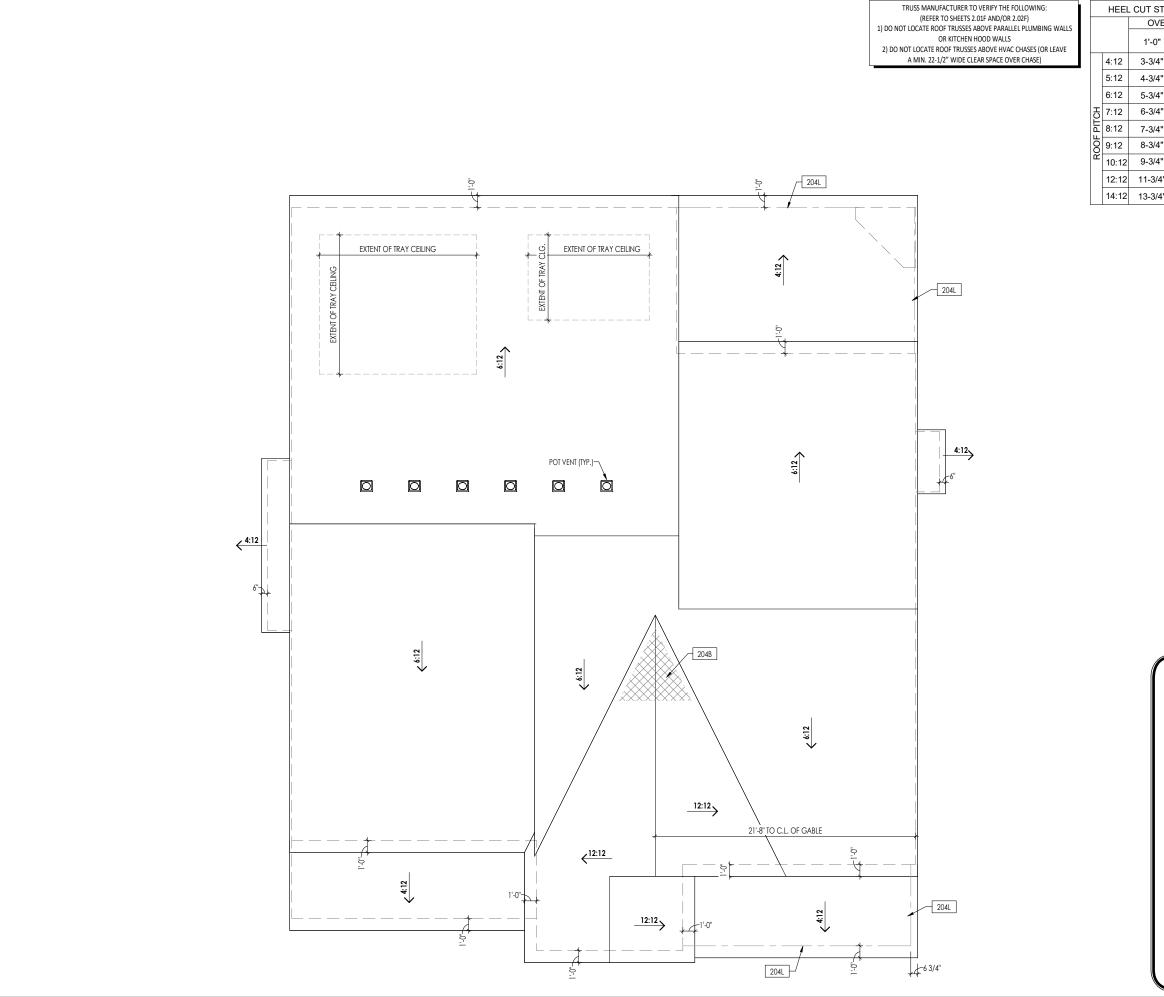

| TANDARDS | | | | |
|----------|---------|--|--|--|
| ERHANG | | | | |
| | 2'-0" | | | |
| ." | 7-3/4" | | | |
| | 9-3/4" | | | |
| ." | 11-3/4" | | | |
| ." | 13-3/4" | | | |
| ." | N/A | | | |
| ." | N/A | | | |
| ." | N/A | | | |
| 4" | N/A | | | |
| 4" | N/A | | | |
| | | | | |

General Notes:

. REFER TO SHEET ON.1 FOR GENERAL NOTES AND SHEET SD-0 FOR ENGINEERING NOTES.


Key Notes:


 204B
 NO ROOF DECKING UNDER OVER-FRAMING IN THIS AREA TO ALLOW FOR PROPER ATTIC VENTILATION

 204L
 BEAM BELOW - RE: SHEET 2.01S FOR SIZE AND LOCATION. DIMENSION SHOWN IS TO FACE OF BEAM

| ROOF VENTILATION | |
|---|-----------|
| CITY/SERIES: | CLEVELAND |
| | Main Roof |
| TOTAL ATTIC AREA: | 2,800 |
| REQUIRED NET FREE VENTILATION (ATTIC AREA/300): | 9.33 |
| ACTUAL NET FREE VENTILATION (UPPER + LOWER): | 9.50 |
| DOWNSPOUT CALCULATION | |
| | Main Roof |
| TOTAL DRAINABLE ROOF AREA: | 3640 |
| MINIMUM # OF DOWNSPOUTS: | 7 |




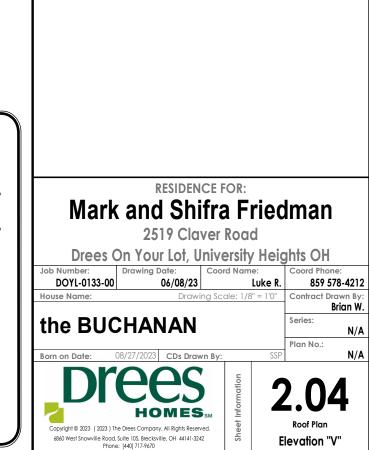

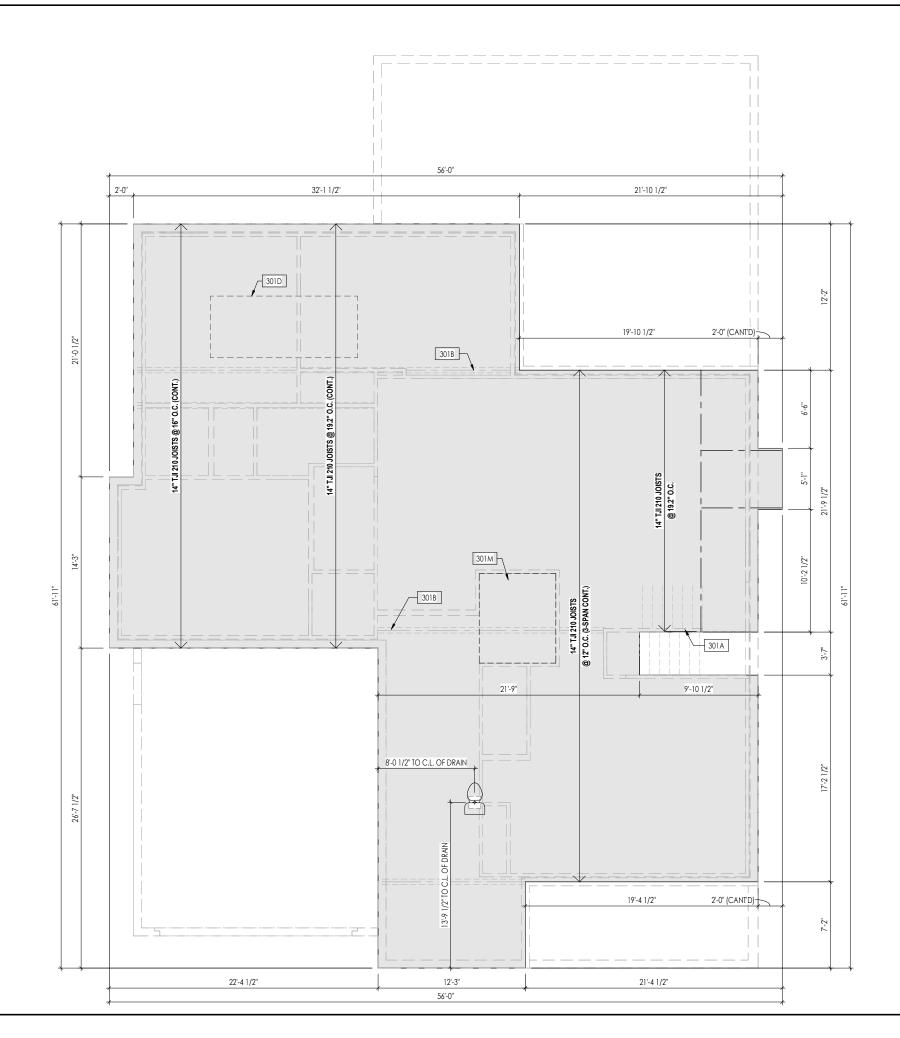


| | Ge | neral Notes: | | | | |
|--|---|--|-------------------|--------------------------|----------------|--|
| | 1. RFF | ER TO SHEET ON.1 FOR GENERAL NOTES. | | | | |
| | 2. FLC | 2. FLOOR JOISTE OW, FOR GENERAL NOTES. 2. FLOOR JOISTS TO BE 14" TJI 210 SERIES, UNLESS OTHERWISE NOTED. 3. JOISTS ARE NOT TO BE PLACE DIRECTLY OVER INTERIOR PARALLEL WALL. | | | | |
| | (TO | PREVENT UNEVEN FLOOR DEFLECTION FROM OCCURRI | NG) | | | |
| | | D'L JOISTS MAY BE LOCATED UP TO 2" AWAY FROM THE IERE MECHANICAL PENETRATIONS | PARTITIO | on wall above in cases | | |
| | | | | | | |
| | Кеγ | / Notes: | | | | |
| | | BEARING WALL BELOW | | | | |
| | | BEAM BELOW - SEE FOUNDATION PLAN FOR MORE INFO | | | 21 | |
| | | OUTLINE OF KITCHEN ISLAND ABOVE - DOUBLE EVERY OTH OHIO ONLY: AREA OF SUBFLOOR TO BE FIREBLOCKED AT | | | | |
| | | FLOOR ASSEMBLY, COMPLYING WITH RCO 302.12 EXCEPT | | | | |
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| | | RESIDENCE F | | | | |
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| | | Mark and Shifra | 3 F | riedman | | |
| | | 2519 Claver | Roa | Id | | |
| | | Drees On Your Lot, Unive | | | | |
| | Job | | rd Nam | | | |
| | | DOYL-0133-00 06/08/23 | | Luke R. 859 578- | | |
| | House Name: Drawing Scale: 1/8" = 1'0" the BUCHANAN | | | | n By: an W. | |
| | | | | Series: | | |
| | LI | | Plan No.: | N/A | | |
| | Born | on Date: 08/27/2023 CDs Drawn By: | | SSP Plan No.: | N/A | |
| | | Drooc | c | | | |
| | | | iatio. | 2 1 | | |
| | | | lform. | 3.01 | | |
| | | Provide a contract of the press Company. All Rights Reserved. | Sheet Information | First Floor Subfloor Plo | an | |
| | | 860 West Snowville Road, Suite 105, Brecksville, OH 44141-3242 | She | Elevation "V" | | |
| | | Phone: [440] 717-9670 | | | | |


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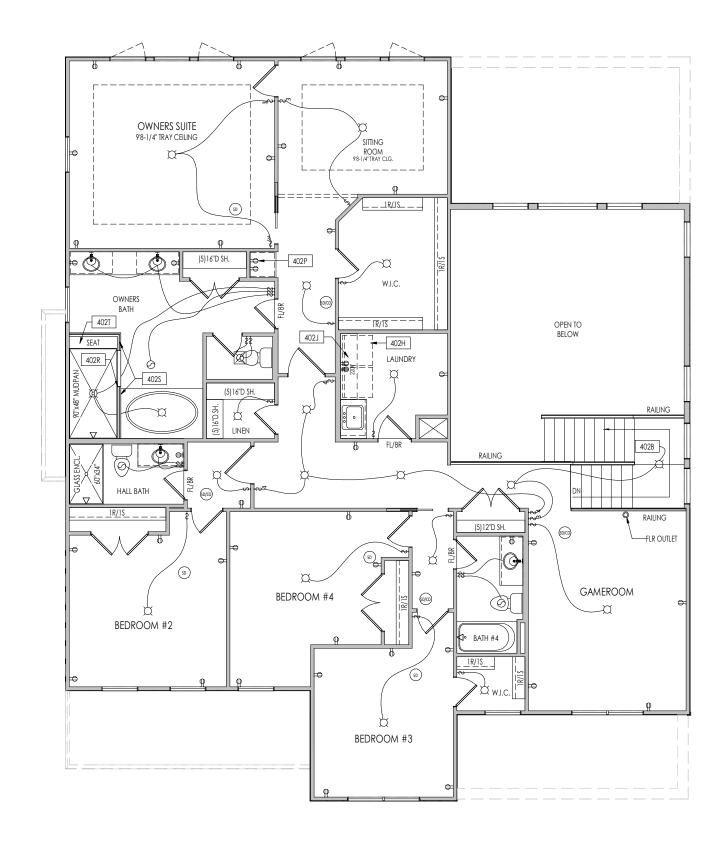
| | * | _ |
|----------------------|--|---|
| | General Notes: | |
| | 1. REFER TO SHEET ON. I FOR GENERAL NOTES. 2. FLOOR JOISTS TO BE" TJI SERIES, OR EQUAL, @" O.C., UNLESS OTHERWISE NOTED. | |
| | 3. JOIST ARE NOT TO BE PLACE DIRECTLY OVER INTERIOR PARALLEL WALL. ITO PREVENT UNEVEN FLOOR DEFLECTION FROM OCCURRING | |
| | ADD'L JOISTS MAY BE LOCATED UP TO 2" AWAY FROM THE PARTITION WALL ABOVE IN CASES WHERE MECHANICAL PENETRATIONS | |
| | | - |
| | Key Notes: 302A BEARING WALL BELOW | _ |
| | 302B BEAM BELOW - SEE SHEET 2.01S FOR MORE INFO | - |
| | 302C FLUSH BEAM - SEE SHEET 2.01S FOR MORE INFO | |
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| 7 | RESIDENCE FOR: | ┫ |
| ω. | Mark and Shifra Friedman | l |
| 7 | | l |
| 6 | 2519 Claver Road | l |
| •• | Drees On Your Lot, University Heights OH Job Number: Drawing Date: Coord Name: Coord Phone: | |
| | DOYL-0133-00 06/08/23 Luke R. 859 578-4212 | |
| ΞI | House Name: Drawing Scale: 1/8" = 1'0" Contract Drawn By: Brian W. | |
| | the BUCHANAN | |
| S | Plan No.: | 1 |
| REISSUED: 07/13/2023 | Born on Date: 08/27/2023 CDs Drawn By: SSP N/A | ┨ |
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| | 6860 West Snowville Road, Suite 105, Brecksville, OH 44141-3242 5 Elevation "V" | |

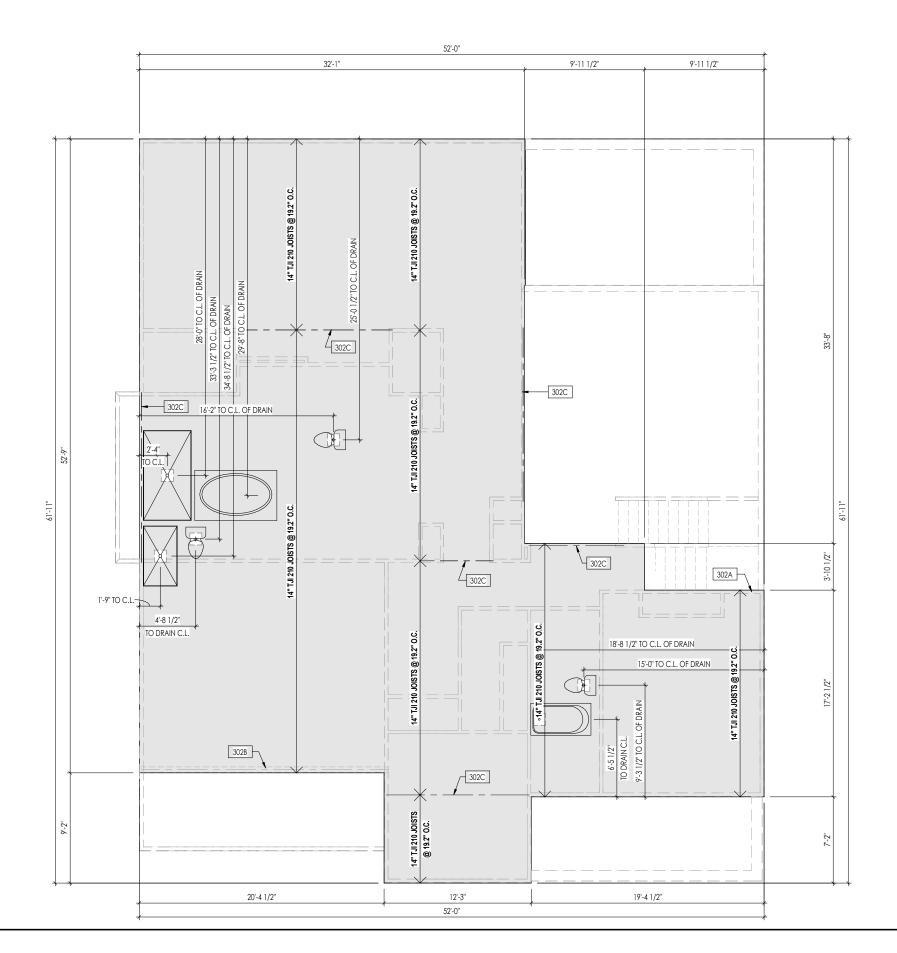

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REISSUED: 07/13/2023

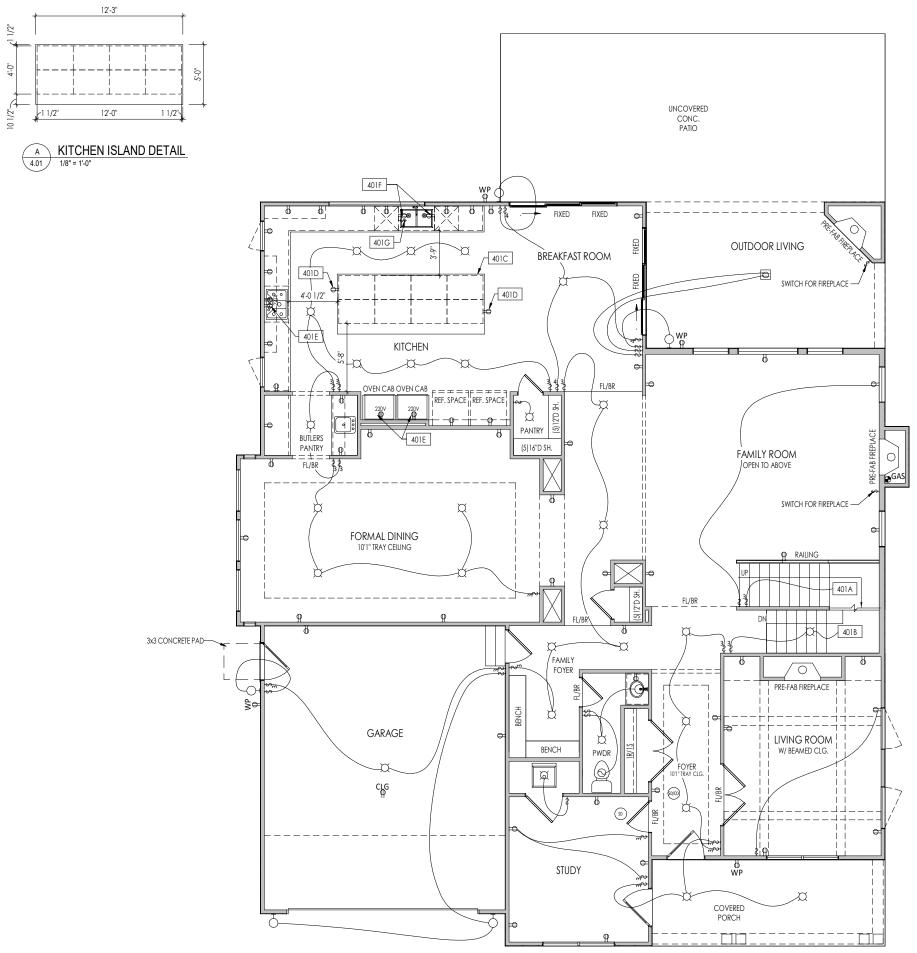

PROVIDE 8' TALL DOORS THROUGHOUT FIRST FLOOR

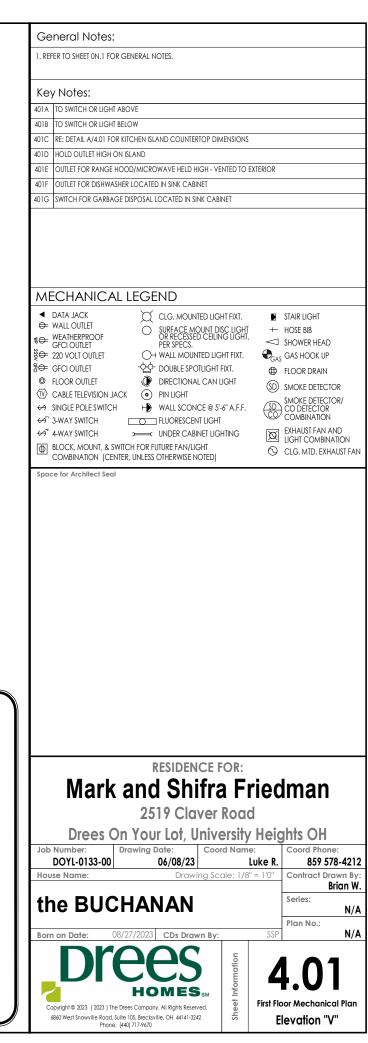
General Notes:

. REFER TO SHEET 0N.1 FOR GENERAL NOTES.

Kov Note


| Key Notes: | | | | |
|------------|---|--|--|--|
| 402B | TO SWITCH OR LIGHT BELOW | | | |
| 402H | LOCATE WASHER TO LEFT OF DRYER | | | |
| 402J | UPPER WALL CABINETS OR 16" DEEP x 5'6" LONG SHELF HELD AT 5'7" A.F.F REFER TO SELECTIONS | | | |
| 402P | HOLD OUTLET LOW FOR UNDER-COUNTER FRIDGE/COOLER | | | |
| 402R | LOCATE SHOWER CONTROLS HERE | | | |
| 402S | 36" HIGH TILED WALL | | | |
| 402T | TILED SHOWER SEAT - SLOPE 3/4" FOR WATER RUN-OFF OVER FLEXIBLE CHLORINATED POLYETHYLENE WATERPROOF MEMBRANE (CONTINUE OVER FRONT AND BACK OF SEAT) | | | |
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MECHANICAL LEGEND

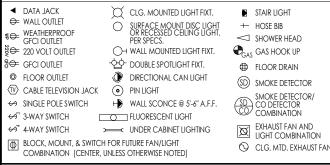

Space for Architect Seal

07/13/2023 • • REISSUED



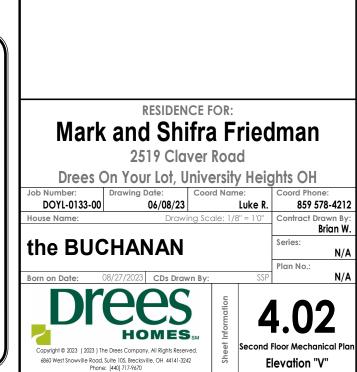

| A | SECTION THRU FOYER |
|------|--------------------|
| 5.01 | 1/8" = 1'-0" |

| | General Notes: |
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| | 1. REFER TO SHEET ON.1 FOR GENERAL NOTES. |
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| | Key Notes: |
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| 3 | RESIDENCE FOR: Mark and Shifra Eriadman |
| 17 | Mark and Shifra Friedman |
| 6 | 2519 Claver Road |
| | Drees On Your Lot, University Heights OH Job Number: Drawing Date: Coord Name: Coord Phone: |
| | DOYL-0133-00 06/08/23 Luke R. 859 578-4212 House Name: Drawing Scale: 1/8" = 1'0" Contract Drawn By: |
| 4 | ba DUCHANAN Series: |
| | the BUCHANAN Series: N/A Plan No.: |
| KEISSUED: 07/13/2023 | Born on Date: 08/27/2023 CDs Drawn By: SSP N/A |
| | |
| | Copyright © 2023 (2023) The Drees Company. All Rights Reserved. |
| —) | Copyright © 2023 (2023) The Drees Company. All Rights Reserved. 6860 West Snowville Road, Suite 105, Brecksville, OH 44141-3242 Elouyation "V" |
| | 6860 West Snowville Road, Suite 105, Brecksville, OH 44141-3242 Phone: [440] 717-9670 Elevation "V" |



| | General Notes: |
|-----------------------------|--|
| RIM: | 1. REFER TO SHEET ON.1 FOR GENERAL NOTES. 2. ROOFING MATERIAL PER SELECTIONS. |
| | REFER TO SHEET S-0 FOR LINTEL SCHEDULE. CONTACT MAK ENGINEERING FOR HEADER SIZE/BRICK SUPPORT IF GRADE DROPS AND THE AMOUNT OF BRICK OVER GARAGE DOOR SHOWN ON CURRENT ELEVATION IS NO LONGER ACCURATE (IF APPLICABLE) |
| ERWISE NOTED) | Key Notes: |
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| 8/2 | RESIDENCE FOR: |
| /13 | Mark and Shifra Friedman |
| 07, | 2519 Claver Road |
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| | Drees On Your Lot, University Heights OH Job Number: Drawing Date: Coord Name: Coord Phone: |
| | Job Number: Drawing Date: Coord Name: Coord Phone: DOYL-0133-00 06/08/23 Luke R. 859 578-4212 House Name: Drawing Scale: 1/8" = 1'0" Contract Drawn By: |
| | Job Number: Drawing Date: Coord Name: Coord Phone: DOYL-0133-00 06/08/23 Luke R. 859 578-4212 House Name: Drawing Scale: 1/8" = 1'0" Contract Drawn By: Brian W. Series: |
| SL | Job Number: Drawing Date: Coord Name: Coord Phone: DOYL-0133-00 06/08/23 Luke R. 859 578-4212 House Name: Drawing Scale: 1/8" = 1'0" Contract Drawn By: Brian W. Brian W. Series: N/A Plan No.: 11/1 |
| ISSL | Job Number: Drawing Date: Coord Name: Coord Phone: DOYL-0133-00 06/08/23 Luke R. 859 578-4212 House Name: Drawing Scale: 1/8" = 1'0" Contract Drawn By: Brian W. Series: N/A Born on Date: 08/27/2023 CDs Drawn By: SSP N/A |
| EISSU | Job Number: Drawing Date: Coord Name: Coord Phone: DOYL-0133-00 06/08/23 Luke R. 859 578-4212 House Name: Drawing Scale: 1/8" = 1'0" Contract Drawn By: Brian W. Brian W. Born on Date: 08/27/2023 CDs Drawn By: SSP N/A Plan No.: DITERES SSP A |
| REISSUED: 07/13/2023 | Job Number: Drawing Date: Coord Name: Coord Phone: DOYL-0133-00 06/08/23 Luke R. 859 578-4212 House Name: Drawing Scale: 1/8" = 1'0" Contract Drawn By: Brian W. Brian W. Series: N/A Plan No.: 11/1 |




| | General Notes: |
|----------------------|--|
| RIM: | 1. REFER TO SHEET ON.1 FOR GENERAL NOTES. |
| | 2. ROOFING MATERIAL PER SELECTIONS. 3. REFER TO SHEET S-0 FOR LINTEL SCHEDULE. |
| | 4. CONTACT M&K ENGINEERING FOR HEADER SIZE/BRICK SUPPORT IF GRADE DROPS AND THE AMOUNT OF BRICK OVER GARAGE DOOR SHOWN ON CURRENT ELEVATION IS NO LONGER ACCURATE (IF APPLICABLE) |
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| /2023 | RESIDENCE FOR: |
| 7/13/2023 | RESIDENCE FOR: Mark and Shifra Friedman |
| : 07/13/2023 | Mark and Shifra Friedman 2519 Claver Road Drees On Your Lot, University Heights OH |
| D: 07/13/2023 | Mark and Shifra Friedman 2519 Claver Road Drees On Your Lot, University Heights OH Job Number: DOYL-0133-00 Drawing Date: 06/08/23 Luke R. |
| ED: 07/13/2023 | Mark and Shifra Friedman 2519 Claver Road Drees On Your Lot, University Heights OH Job Number: Drawing Date: Coord Name: Coord Phone: DOYL-0133-00 06/08/23 Luke R. 859 578-4212 House Name: Drawing Scale: 1/8" = 1"0" Contract Drawn By: Brian W. |
| UED: 07/13/2023 | Mark and Shifra Friedman 2519 Claver Road Drees On Your Lot, University Heights OH Job Number: Drawing Date: Coord Name: Coord Phone: DOYL-0133-00 06/08/23 Luke R. 859 578-4212 House Name: Drawing Scale: 1/8" = 1'0" Contract Drawn By: |
| SUED: 07/13/2023 | Mark and Shifra Friedman 2519 Claver Road Drees On Your Lot, University Heights OH Job Number: Drawing Date: Coord Name: Coord Phone: DOYL-0133-00 06/08/23 Luke R. 859 578-4212 House Name: Drawing Scale: 1/8" = 1'0" Contract Drawn By: Brian W. the RUCHANIAN Series: |
| ISSUED: 07/13/2023 | Mark and Shifra Friedman 2519 Claver Road Drawing Date: Coord Name: DoyL-0133-00 Dofo8/23 Coord Name: Coord Phone: DoyL-0133-00 Drawing Date: Coord Name: Coord Phone: 859 578-4212 House Name: Drawing Date: Coord Name: Coord Phone: 859 578-4212 House Name: Drawing Scale: 1/8" = 1'0" Contract Drawn By: Brian W. Series: N/A Born on Date: 08/27/2023 CDs Drawn By: SSP N/A |
| EISSUED: 07/13/2023 | Mark and Shifra Friedman 2519 Claver Road Drawing Date: Coord Name: Dordving Date: Coord Name: Coord Phone: DoyL-0133-00 06/08/23 Luke R. 859 578-4212 House Name: Drawing Date: Coord Name: Coord Phone: Born on Date: 08/27/2023 Cos Drawn By: SSP N/A |
| REISSUED: 07/13/2023 | Mark and Shifra Friedman 2519 Claver Road Drees On Your Lot, University Heights OH Job Number: DOYL-0133-00 Drawing Date: Coord Name: 859 578-4212 House Name: Drawing Scale: 1/8" = 1'0" Contract Drawn By: Brian W. the BUCHANAN Series: N/A Plan No.: 1/10" 1/11" |




| | General Notes: |
|-----------------------------|---|
| FRIM: | 1. REFER TO SHEET ON.1 FOR GENERAL NOTES. |
| A | 2. ROOFING MATERIAL PER SELECTIONS. 3. REFER TO SHEET S-0 FOR LINTEL SCHEDULE. |
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| 3/ | Mark and Shifra Friedman |
| 5 | 2519 Claver Road |
| 6 | Drees On Your Lot, University Heights OH |
| | Job Number: Drawing Date: Coord Name: Coord Phone: |
| | House Name: Drawing Scale: 1/8" = 1'0" Contract Drawn By: |
| 4 | the BUCHANAN Brian W. |
| 5 | |
| | Plan No.: |
| S | Born on Date: 08/27/2023 CDs Drawn By: SSP N/A |
| П. | Born on Date: 08/27/2023 CDs Drawn By: SSP N/A |
| REIS: | Born on Date: 08/27/2023 CDs Drawn By: SSP N/A |
| REISSUED: 07/13/2023 | Born on Date: 08/27/2023 CDs Drawn By: SSP M/A Drees 6.03 |



| | General Notes: |
|-----------------------------|---|
| RIM: | 1. REFER TO SHEET ON.1 FOR GENERAL NOTES. |
| х Х | 2. ROOFING MATERIAL PER SELECTIONS. 3. REFER TO SHEET S-0 FOR LINTEL SCHEDULE. |
| ERWISE NOTED) | |
| , | Key Notes: |
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| 3/202 | RESIDENCE FOR: Mark and Shifra Eriadman |
| /13/202 | Mark and Shifra Friedman |
| 07/13/202 | Mark and Shifra Friedman 2519 Claver Road |
| : 07/13/202 | Mark and Shifra Friedman |
| D: 07/13/202 | Mark and Shifra Friedman 2519 Claver Road Drees On Your Lot, University Heights OH Job Number: DOYL-0133-00 Drawing Date: Coord Name: Coord Phone: DOYL-0133-00 06/08/23 Luke R. 859 578-4212 |
| JED: 07/13/202 | Mark and Shifra Friedman 2519 Claver Road Drees On Your Lot, University Heights OH Job Number: DoyL-0133-00 Drawing Date: Coord Name: Coord Phone: DOYL-0133-00 06/08/23 Luke R. 859 578-4212 House Name: Drawing Scale: 1/8" = 1'0" Contract Drawn By: Brian W. Brian W. |
| UED: 07/13/202 | Mark and Shifra Friedman 2519 Claver Road Drees On Your Lot, University Heights OH Job Number: Drawing Date: Coord Name: Coord Phone: DOYL-0133-00 06/08/23 Luke R. 859 578-4212 House Name: Drawing Scale: 1/8" = 1'0" Contract Drawn By: Brian W. the BUCHANAN Series: N/A |
| SUED: 07/13/202 | Mark and Shifra Friedman 2519 Claver Road Drees On Your Lot, University Heights OH Job Number: Drawing Date: Coord Name: Coord Phone: DOYL-0133-00 06/08/23 Luke R. 859 578-4212 House Name: Drawing Scale: 1/8" = 10" Contract Drawn By: Brian W. tho BLICHANIAN Series: |
| ISSUED: 07/13/202 | Mark and Shifra Friedman 2519 Claver Road Drees On Your Lot, University Heights OH Job Number: Drawing Date: Coord Name: Coord Phone: DOYL-0133-00 06/08/23 Luke R. 859 578-4212 House Name: Drawing Scale: 1/8" = 1'0" Contract Drawn By: Brian W. Series: N/A Born on Date: 08/27/2023 CDs Drawn By: SSP |
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| REISSUED: 07/13/2023 | Mark and Shifra Friedman 2519 Claver Road Drees On Your Lot, University Heights OH Job Number: Drawing Date: Coord Name: B59 578-4212 House Name: Drawing Scale: 1/8" = 1'0" Contract Drawn By: Brian W. House Name: Drawing Scale: 1/8" = 1'0" Contract Drawn By: Brian W. Born on Date: 08/27/2023 CDs Drawn By: SSP N/A |

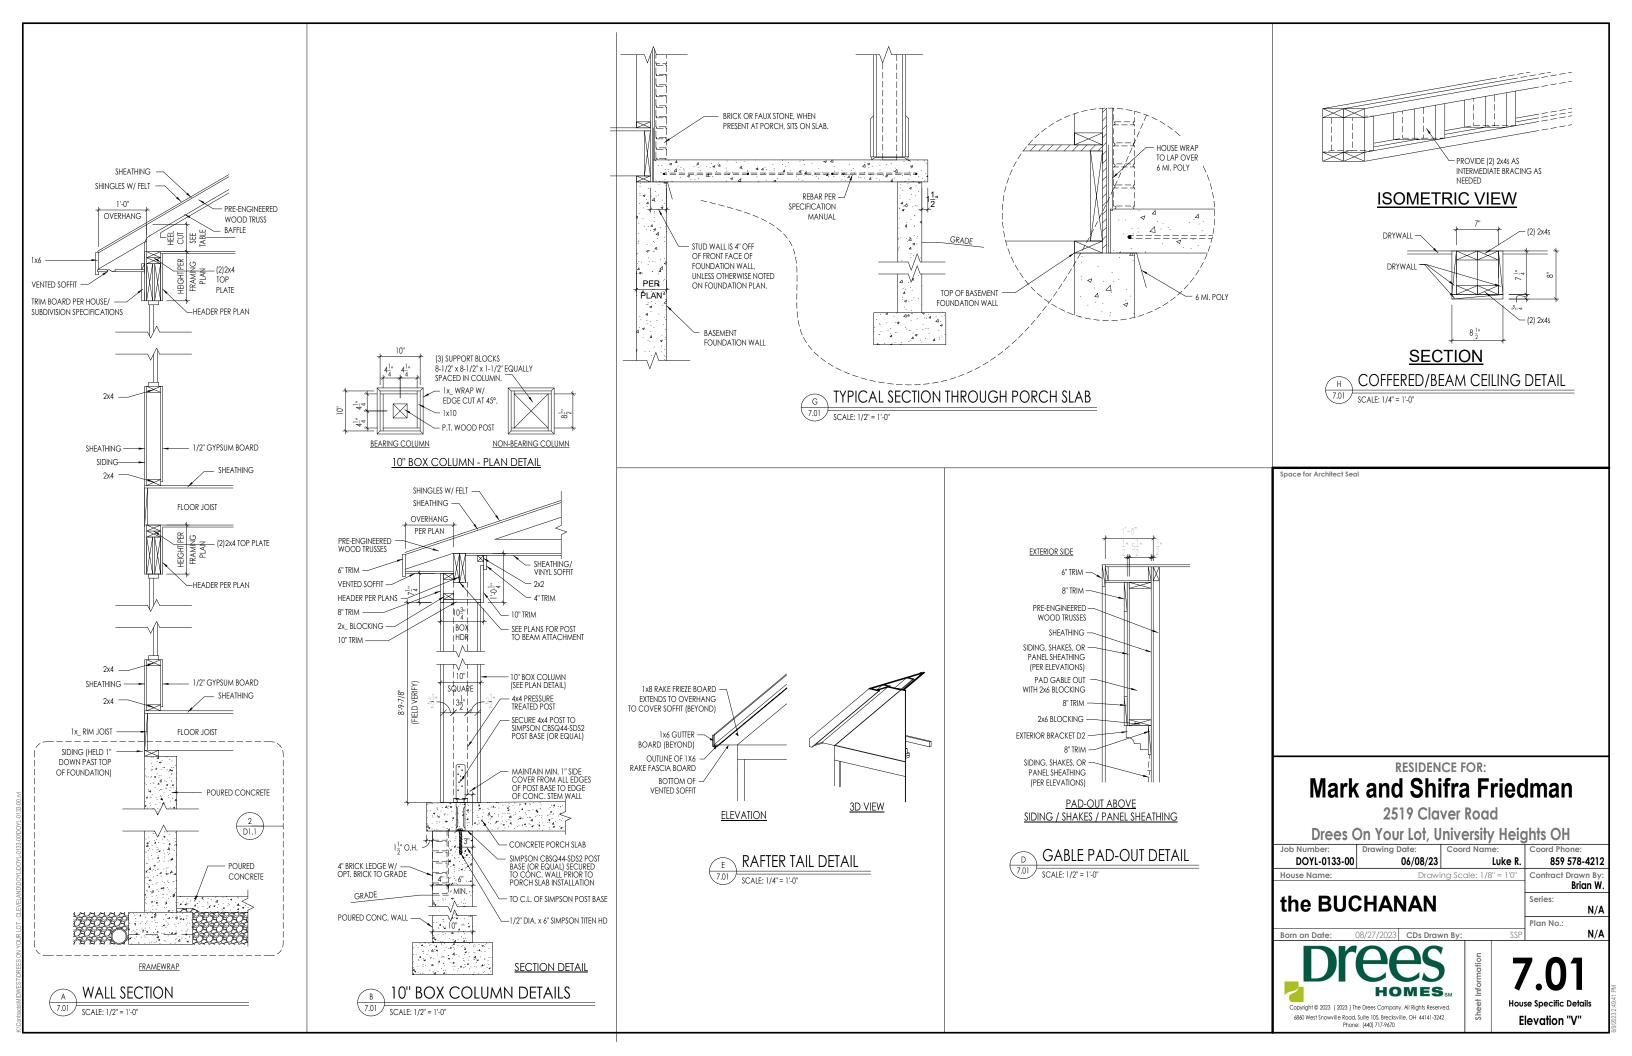


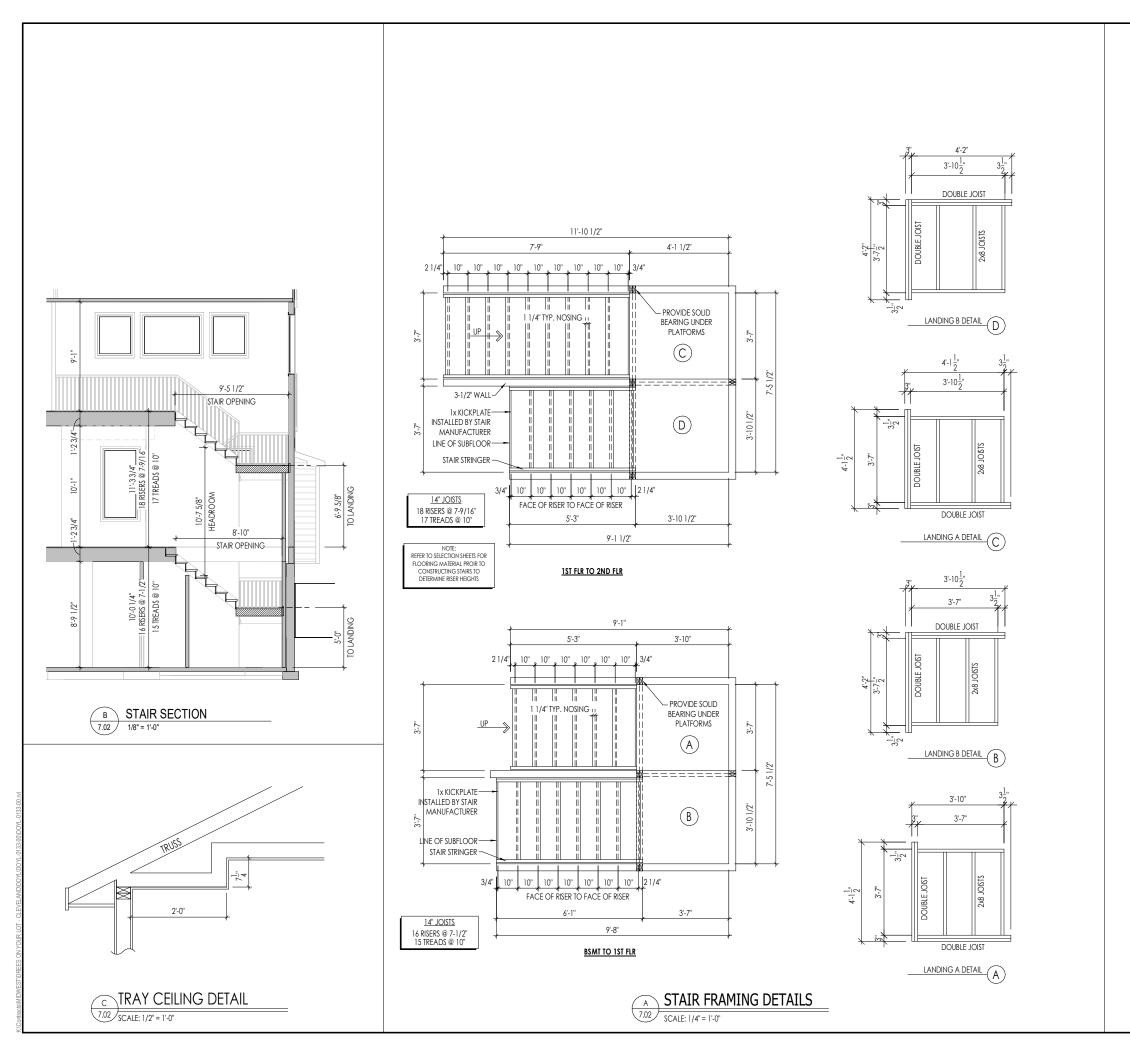

1. REFER TO SHEET ON.1 FOR GENERAL NOTES. 2. REFER TO SELECTION SHEETS FOR FLOORING MATERIAL PRIOR TO CONSTRUCTING STAIRS TO DETERMINE RISER HEIGHTS

Key Notes:



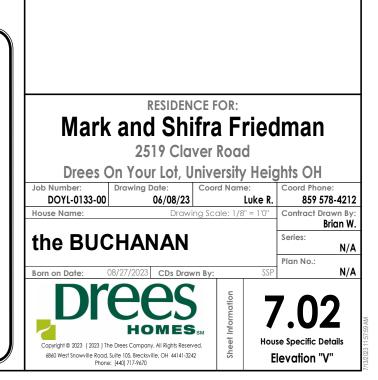

| CONNECTION SPECIFICATIONS (TYP. U.N.O.) | | | | VENEER LI | NTEL SCHEDULE | GENERAL STRUCTURAL NOTES | LATERAL/WALL BRACING & WALL |
|---|---------------------------|--|------------------|---|--|--|---|
| | | SPAN (MAX) | HEIGHT OF VENEER | STEEL ANGLE SIZE | | SHEATHING SPECIFICATIONS | |
| | NOTE: 10d NAIL = 3" × 0.1 | 31" GUN NAIL | (MAX) 3'-0" | ABOVE LINTEL 20 FT. MAX | L4"x3"x44" | FOUNDATION | THIS MODEL HAS BEEN DESIGNED TO RESIST |
| JOIST TO SOLE PL | 1 ATE (3)10d 1 | roenails | | 3 FT. MAX | L4"x3"x4 | • DESIGN IS BASED ON 2019 OHIO RESIDENTIAL CODE. | LATERAL FORCES RESULTING FROM: |
| SOLE PLATE TO J | JOIST/BLK'G. IOd NAI | LS 0 6" o.c. | 6'-0" | I6 FT. MAX | L5"x3"x%" | | II5 MPH WIND IN 2019 RCO MAP |
| STUD TO SOLE PL | | roenails | 8'-0" | 6 FT. MAX | L5"x3"x%" | FOOTING DESIGN - 1,500 PSF NET ALLOWABLE SOIL BEARING PRESSURE IS ASSUMED, BUILDER/CONTRACTOR MUST VERIFY. | (115 MPH WIND SPEED |
| RIM TO TOP PLAT | | ENAILS @ 6" O.C. | 9'-6" | 3 FT. MAX | L5"x3"x%" | | IN ASCE 7 WIND MAP) |
| BLK'G. BTWN. JOIS | | roenails | 12'-0" | 2 FT. MAX | L5"x3"x%" | FASTEN 2x SILL PLATES TO CONC FND WITH A MINIMUM OF 2 ANCHORS PER PLATE, 12" MAX. FROM PLATE ENDS - UTILIZING: | EXP. B & SEISMIC CAT. A/B. |
| RAFTER/TRUSS TO | | FOENAILS + PSON H2.5A | ALL LINTELS | | - | I/2" DIA. ANCHOR BOLTS @ 6'-0" O.C.,7" MIN. EMBEDMENT | |
| GAB. END TRUSS 1 | TO DBL. TOP PL. 10d TOE | | < 16' SHALL SUP | Have 4" Min. Bearing Have 8" Min. Bearing | R w/ 40 pef Maximum Weight. | • SIMPSON MAB STRAPS • 32" O.C. | THE DESIGN WAS COMPLETED PER 2017 OBC (SECTION 1609) & ASCE 7, AS PERMITTED BY |
| R.T. w/ HEEL HT. 9 | | K EVERY 3RD BAY | < 12' SHALL | NOT BE FASTENED BACK | TO HEADER. NOOD HEADER IN WALL @48°0.c. w/发" DIA. x 3发" | SIMPSON MASA ANCHOR STRAPS @ 6'-0" O.C. | R301.1.3 OF THE 2019 RCO. ACCORDINGLY, THIS |
| | | NED TO DBL. TOP PLATE TOENAILS © 6" O.C. | - MAX, VENE | g screms in 2" long ve Er ht. Applies to any i | RTICALLY SLOTTED HOLES. | ALL LUMBER EXPOSED TO WEATHER OR IN CONTACT W PERIMETER FOUNDATION SHALL BE PRESERVATIVE TREATED SOUTHERN PINE #2. | MODEL, AS DOCUMENTED AND DETAILED |
| R.T. w/ HEEL HT. 12 | 2" TO 16" 2x12 BL | LK EVERY 3RD BAY | - ALL LINTE | ls shall be long leg v Ls shall be made of 30 | KSI STEEL. | | HEREWITHIN, IS ADEQUATE TO RESIST THE CODE REQUIRED LATERAL FORCES, AND DOES NOT |
| | | NED TO DBL. TOP PLATE TOENAILS © 6" O.C. | - MHEN SUPP | Be out in the field to b | THE EXTERIOR TOE OF THE HORIZONTAL LEG 3 /4" WIDE OVER THE BEARING LENGTH ONLY. JOINT FINISHING. | BUILDER TO VERIFY CORROSION-RESISTANCE COMPATIBILITY OF HARDWARE & FASTENERS IN CONTACT W/ PRESERVATIVE-TREATED | NEED TO CONFORM TO THE PRESCRIPTIVE |
| R.T. W/ HEEL HT. UF | | ALL SHTG. W/ DBL. TOP PL. | - SEE STRUC | TURAL PLANS FOR ANY L RAMETERS. | NTEL CONDITION NOT ENCOMPASSED BY THE | WOOD. CONTACT LUMBER & HARDWARE SUPPLIERS TO COORD. | PROVISIONS OF SECTION R602.10 WITHIN THE |
| | € INSTA | ALL ON TRUSS VERT | | | MIK STND MAY 2016 | • FOUNDATION WALLS & FOOTINGS SHALL BE PLAIN CONCRETE, U.N.O. | 2019 RCO. |
| | | N W/ 8d NAILS @ 6" O.C. | | | | | |
| R.T. w/ HEEL HT. 2 | | ALL SHTG. W/ DBL. TOP PL. ALL ON TRUSS VERT | | | | CONCRETE DESIGN BASED ON ACI 318. CONCRETE SHALL ATTAIN THE FOLLOWING MIN. COMPRESSIVE STRENGTHS IN 28 DAYS, U.N.O.: | EXT. WALL SHEATHING SPECIFICATION |
| 1 | FASTEN | N w/ 8d NAILS @ 6" O.C. | | | | f'c = 4,000 psi: FOUNDATION WALLS | • 7/16" OSB OR 15/32" PLYWOOD: |
| 1 | PROVID TOP OF | DE 2x BLK @ EA. BAY AT | | | | 3,000 psi: FOOTINGS & INTERIOR SLABS ON GRADE 3,500 psi: GARAGE & EXTERIOR SLABS ON GRADE | ■ 1/10 USD UK 15/32 FLTMOUD: FASTEN SHEATHING W/ 2 ³/₈"x0.113 NAILS @ 6" O.C. AT |
| DOUBLE STUD | | LS @ 24" o.c. | | | | fy = 60,000 psi | EDGES & @ 12" O.C. IN THE PANEL FIELD. (TYP, U.N.O.) |
| DOUBLE TOP PLAT | TE IOd NAI | LS @ 24" o.c. | | | | BASEMENT FOUNDATION WALL DESIGN BASED ON: | ALL SHEATHING PANELS SHALL BE ORIENTED |
| DOUBLE TOP PLAT | | NAILS IN LAPPED AREA | | L | GEND | • 8' OR 9' HEIGHT (AS NOTED ON PLANS) | VERTICALLY (LONG DIRECTION PARALLEL TO STUDS) AND INSTALLED FULL HEIGHT OF SHEAR WALL - OR - |
| INTERSECTING WAI | | VILO | _ | | | - TALLER WALLS MUST BE ENGINEERED. | 2x HORIZONTAL BLOCKING SHALL BE PROVIDED TO |
| WALL TO FOUNDAT | | HTG. LAP W/ SILL PL. & | • 🗆 | INTERIC | R BEARING WALL | NOMINAL WIDTH (8" FOR 8' WALL, 10" FOR 10' WALL). | SUPPORT ALL UNSUPPORTED PANEL EDGES & EDGE FASTENING. |
| | | NED PER SHEAR WALL NING SPEC. | • = | BEARIN | 5 WALL ABOVE | BASEMENT WALL DESIGN IS BASED ON 30 OR 45 PCF BACKFILL | |
| | | | | BEAM / | HEADER | SOIL TYPE CLASSIFICATIONS: 30 PCF TYPE (GW, GP, SW, SP) | ALL EXT. WALLS SHALL BE CONTINUOUSLY SHEATHED AND ARE CONSIDERED SHEAR WALLS. |
| 5 | GARAGE | = GLAB | | | | 45 PCF TYPE (GM, GC, SM, SM-SC, ML) | ALT. STAPLE CONNECTION SPEC: 1 3/4" 16 GA STAPLES |
| | 4" CONC. SLAB | | • [: | EXTENT | OF OVERFRAMING | <u>IMPORTANT</u> - IF 60 PCF SOIL TYPE (SC, ML-CL, OR CL) IS UTILIZED FOR BACKFILL, CONTACT MULHERN & KULP FOR | (1/6" CROWN) @ 3" O.C. AT EDGES & @ 6" O.C IN FIELD. |
| | WHE ON 6 MIL V | | يد ه | L METAL | HANGER | FURTHER EVALUATION OF FOUNDATION DESIGN. | |
| | ON 4" MIN. GRANU | | | | | BASEMENT WALLS SHALL BE BRACED, PRIOR TO BACKFILLING, BY | <u>3" O.C. EDGE NAILING</u> |
| | COMPACTED FI | LL/VIRGIN SOIL | | | ES EXTENT OF INT. OSB WALL, BLOCKED PANEL EDGES, | ADEQUATE TEMPORARY BRACING OR INSTALL IST FLOOR DECK. | AT DESIGNATED AREAS - FASTEN PANEL EDGES OF |
| | PORCH | SI AB | | AND/OF | 3" O.C. EDGE NAILING | • PROVIDE (2) #5 BARS AROUND ALL SIDES OF OPENINGS IN | WOOD STRUCTURAL WALL SHEATHING TO FRAMING W/ 2 ⅔" × 0.113" NAILS @ 3" O.C. AND 12" O.C. IN THE |
| | | <u></u> | • | | ES HOLDOWN | CONCRETE BSMT. FND. WALL WITH 2" CLEAR. REINFORCEMENT | PANEL FIELD NO STAPLE ALTERNATIVE AVAILABLE |
| | | FILL/VIRGIN SOIL | | | | SHALL EXTEND 12" PAST CORNER OF OPENING IN ALL DIRECTIONS. FOR OPENINGS UP TO 36", PROVIDE MINIMUM 10" CONCRETE | AT THIS SPEC. ALL SHEATHING PANELS SHALL BE ORIENTED VERTICALLY (LONG DIRECTION PARALLEL |
| | | | • | | es post above (p.a.) provide | DEPTH OVER OPENING OR (3)2x10 w/(2)2x6 JACK STUDS, U.N.O. | TO STUD) AND INSTALLED FULL HEIGHT OF SHEAR |
| | BASEMEN | NT SLAB | | SOLID I | BLOCKING UNDER POST OR JAMB | LARGER OPENINGS SHALL BE PER PLAN. | WALL - OR - 2X HORIZONTAL BLOCKING SHALL BE |
| | 4" CONC. SLAB ON 6 | MIL VAPOR BARRIER | | ABOVE | | • ALL CONCRETE EXPOSED TO THE WEATHER SHALL NOT HAVE LESS | PROVIDED TO SUPPORT UNSUPPORTED PANEL EDGES AND 3" O.C. EDGE FASTENING. |
| | | NULAR FILL ON | | | | THAN 5% OR MORE THAN 7% AIR ENTRAINMENT. | |
| | 95% COMPACTED | FILL/VIKGIN SOIL | AD | DITIONAL N | OTES FOR TRUSS \$ | • ALL FOOTINGS SHALL BEAR BELOW FROST LINE (TYP.) OR 12" MIN IN | <u>NOTES</u> |
| | SLAB ON | GRADE | | I-JOIST M | ANUFACTURER | REGIONS WHERE CODE FROST DEPTH IS NOT APPLICABLE. CONSULT SOILS REPORT OR BUILDING DEPT. FOR MINIMUM DEPTH BELOW | • SEE CONNECTION SPECIFICATIONS CHART FOR |
| | 4" CONC. SLAB W/ 6X | | | | ISS AND ENGINEERED | GRADE. | STANDARD SHEAR TRANSFER DETAILING. IF ADDITIONAL CAPACITY IS REQUIRED BY DESIGN, |
| | | ON 4" MIN. GRANULAR | | | NED TO MEET THE ELOW, UNLESS NOTED | • FOOTINGS AND SLABS ON GRADE SHALL BEAR ON VIRGIN SOIL OR | IT WILL BE SPECIFICALLY NOTED ON PLAN. |
| Ŧ | FILL ON 95% COMPAC | TED FILL/VIRGIN SOIL | OTHERM | NISE <i>O</i> N PLAN. MI | LHERN & KULP CANNOT BE | 95% COMPACTED FILL. | • DESIGN ASSUMES 16" O.C MAX. STUD SPACING, U.N.O. |
| | | | | | ANY STRUCTURAL ISSUES NG COMPONENT IF | PROVIDE CONTROL JOINTS AT ALL INSIDE CORNERS OF SLAB EDGES AND OTHER LOCATIONS INVERSE & AB CRACKS ARE LIKELY | • ALL STRUCTURAL PANELS ARE TO BE DIRECTLY |
| | | | | | INGS ARE NOT SUBMITTED | EDGES, AND OTHER LOCATIONS WHERE SLAB CRACKS ARE LIKELY TO DEVELOP. | APPLIED TO STUD FRAMING. |
| | | | TO M&K | | OR TO FABRICATION, | • JOINTS SHALL BE LOCATED @ 10'-0" O.C. (RECOMMENDED) OR | P <u>RE-MANUFACTURED PANELIZED WALLS:</u> FASTEN TOGETHER END STUDS OF WALL PANELS |
| | | | | | TION. BE DESIGNED SO THAT | 15'-0" O.C. (MAXIMUM) • JOINT GRID PATTERN SHALL BE AS CLOSE TO SQUARES AS | SHEATHED W/ OSB OR PLYWOOD W/ IOD NAILS |
| | | | DIFFERE | ENTIAL DEFLECTI | ON BETWEEN ADJACENT | POSSIBLE (1:1 RATIO), WITH A MAXIMUM OF 1:1.5 RATIO | @ 4" O.C. (THRU ONE SIDE ONLY) MIK STIND DEC. 2015 |
| | | | | | TS OR GIRDER TRUSSES/FLUSH THE FOLLOWING: | CONTROL JOINTS SHALL <u>NOT</u> BE INSTALLED IN STRUCTURAL SLABS | J |
| | | | A. RO | OF TRUSSES: | | • TYPICAL REINFORCEMENT DETAILS: PROVIDE 3" MIN. CLEAR | |
| \square | | | | DEAD LOAD | TIC TRUSSES, & I-JOISTS: | • ITPICAL REINFORCEMENT DETAILS: PROVIDE 5" MIN. CLEAR COVER WHERE CAST AGAINST EARTH, 1 1/2" MIN. CLEAR COVER | |
| | | | | " DEAD LOAD | | AGAINST FORMS. LAP ALL REBAR 48 BAR DIAMETERS MIN. (24" | |
| n m | | | | | DEFECTION OF FLOOR WHEN ADJACENT TO FLOOR | FOR #4 BARS) & BEND BARS AND LAP AT CORNERS. PROVIDE 6" HOOK INTO SUPPORTING FOOTINGS WHEN FOOTINGS INTERSECT. | |
| | | | | | ALL BE LIMITED TO 3/16". (NOT | • DIMENSIONS BY OTHERS, BUILDER TO VERIFY. | |
| | | | | ENTIAL DEFLECT | | MIK STND MAY 2012 | |
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GENERAL STRUCTURAL NOTES

FLOOR FRAMING

 I-JOISTS/TRUSSES SHALL BE DESIGNED BY MANUF. TO MEET OR EXCEED L/480 LIVE LOAD DEFLECTION CRITERIA. (EXCLUDES STONE/MARBLE OR WET BED CONSTRUCTED FLOORS - CONTACT MAK FOR EXCLUDED FLOOR DESIGNS)
 PER THE GUIDELINES OF THE TILE COUNCIL OF NORTH AMERICA

(CINA HANDBOOK), IT SHALL BE THE FLOOR FINISH INSTALLER'S RESPONSIBILITY TO VERIFY THAT THE FINISHES TO BE INSTALLED MATCH THE DESIGN CRITERIA NOTED ABOVE (INDER "DESIGN LOADS").

• AT I-JOIST FLOORS, PROVIDE I 1/8" MIN. OSB RIM BOARD.

METAL HANGERS SHALL BE SPECIFIED BY MANUFACTURER, U.N.O.
 I-JOIST/TRUSS SHOP DWGG. SHALL BE SUBMITTED TO ARCH. & ENG.
 FOR REVIEW AND APPROVAL PRIOR TO FABRICATION OR DELIVERY

- FLOOR SHEATHING SHALL BE 23/32" A.P.A. RATED 'STURD-I-FLOOR'
 24" O.C. EXPOSURE I (OR APPROVED EQUAL) WITH TONGUE AND
- GROOVE EDGES. FASTEN TO FRAMING MEMBERS W GLUE AND $-2\frac{1}{2}$ × 0.131° NAILS \bullet 6°0... \bullet PANEL EDGES \ddagger \bullet 12°0... FIELD. $-2\frac{3}{2}$ × 0.120° NAILS \bullet 4° 0... \bullet PANEL EDGES \ddagger \bullet 6° 0... FIELD.
- 2 g × 0.13" NAILS 3" O.C. PANEL EDGES \$ 6" O.C. IN FIELD.

ROOF FRAMING

ROOF SHEATHING SHALL BE 1/16" A.P.A. RATED SHEATHING 24/16
 EXPOSURE I (OR APPROVED EQUAL), FASTEN TO FRAMING MEMBERS

- W/2 ½" × 0.131" NAILS @ 6"0C. @ PANEL EDGES \$ @ 12" O.C. FIELD. - W/2 35" × 0.120" NAILS @ 4"0C. @ PANEL EDGES \$ @ 8" O.C. FIELD.

- W/ 2 🐉 × 0.113" NAILS @ 3"0.c. @ PANEL EDGES \$ @ 6" O.C. FIELD.

• WITHIN 48" OF ALL ROOF EDGES, RIDGES, & HIPS FASTEN ROOF SHEATHING FIELDS PER EDGE NAILING SPEC.

FASTEN EACH ROOF TRUSS TO TOP PLATE W/ SIMPSON H25A CLIP (OR APPROVED EQUAL) © ALL BEARING POINTS. PROVIDE (2) H25A CLIPS AT 2-PLY GIRDER TRUSSES, (3) H25A CLIPS AT 3-PLY GIRDER TRUSSES & ROOF BEAMS - AT ALL BEARING POINTS.
METAL HANGERS SHALL BE SPECIFIED BY THE MANUFACTURER, U.N.O.
ROOF TRUSS SHOP DWGS. SHALL BE SUBMITTED TO ARCH & ENG. FOR REVIEW AND APPROVAL PRIOR TO FABRICATION OR DELIVERY
ERECT AND INSTALL ROOF TRUSSES PER WICA & TPIS BCGI I "GUIDE TO GOOD PRACTICE FOR HANDLING, INSTALLING & BRACING OF METAL PLATE CONNECTED WOOD TRUSSES."


• SUPPORT SHORT SPAN ROOF TRUSSES w/2x4 LEDGER FASTENED TO FRAMING w/(2) 3" x 0.120" NAILS • 16" O.C. (UP TO T' SPAN).


MEANS & METHODS NOTES

THE STRUCTURE IS DESIGNED TO BE SELF SUPPORTING AND STABLE AFTER THE BUILDING IS FINISHED AND ALL PLAN, DETAIL, AND NOTE SPECIFICATIONS HAVE BEEN COMPLETED. IT IS THE CONTRACTOR'S SOLE RESPONSIBILITY TO DETERMINE THE ERECTION PROCEEDURES AND SEQUENCE TO INSURE THE SAFETY OF THE BUILDING AND ITS COMPONENTS DURING CONSTRUCTION. THIS INCLUDES, BUT IS NOT LIMITED TO, THE ADDITION OF INCLESCARY SHORING AND TIE-DOINNG. CONTRACTOR SHALL BE RESPONSIBLE FOR ALL SHORING AND BRACING, RUTS, AND TIE-DOING. CONTRACTOR SHALL BE RESPONSIBLE FOR ALL SHORING AND BRACING REQUIRED TO STABILIZE AND PROTECT EXISTING AND ADJACENT STRUCTURES AND SYSTEMS DURING COURSE OF DEMOLITION AND CONSTRUCTION OF THE PROCING.

STRUCTURAL DESIGN AND SPECIFICATIONS ASSUME THAT ALL SUPPORTING AND NON-SUPPORTING ELEMENTS IN CONTACT WITH FLOOR FRAMING ARE LEVEL, INCLUDING, BUT NOT LIMITED TO; FOUNDATIONS, SLABG ON GRAPE, BEAMS, WALLS, AND NON-BEARING ELEMENTS. IT IS THE CONTRACTOR'S RESPONSIBILITY TO VERIFY LEVELNESS AND MAKE ADJUSTNENTS AS NECESSARY, INCLUDING CONSIDERATION OF THOSE AREAS THAT MAY DE WITHIN CONTRACTUAL, INDUSTRY, OR WARRANTY TOLERANCES.


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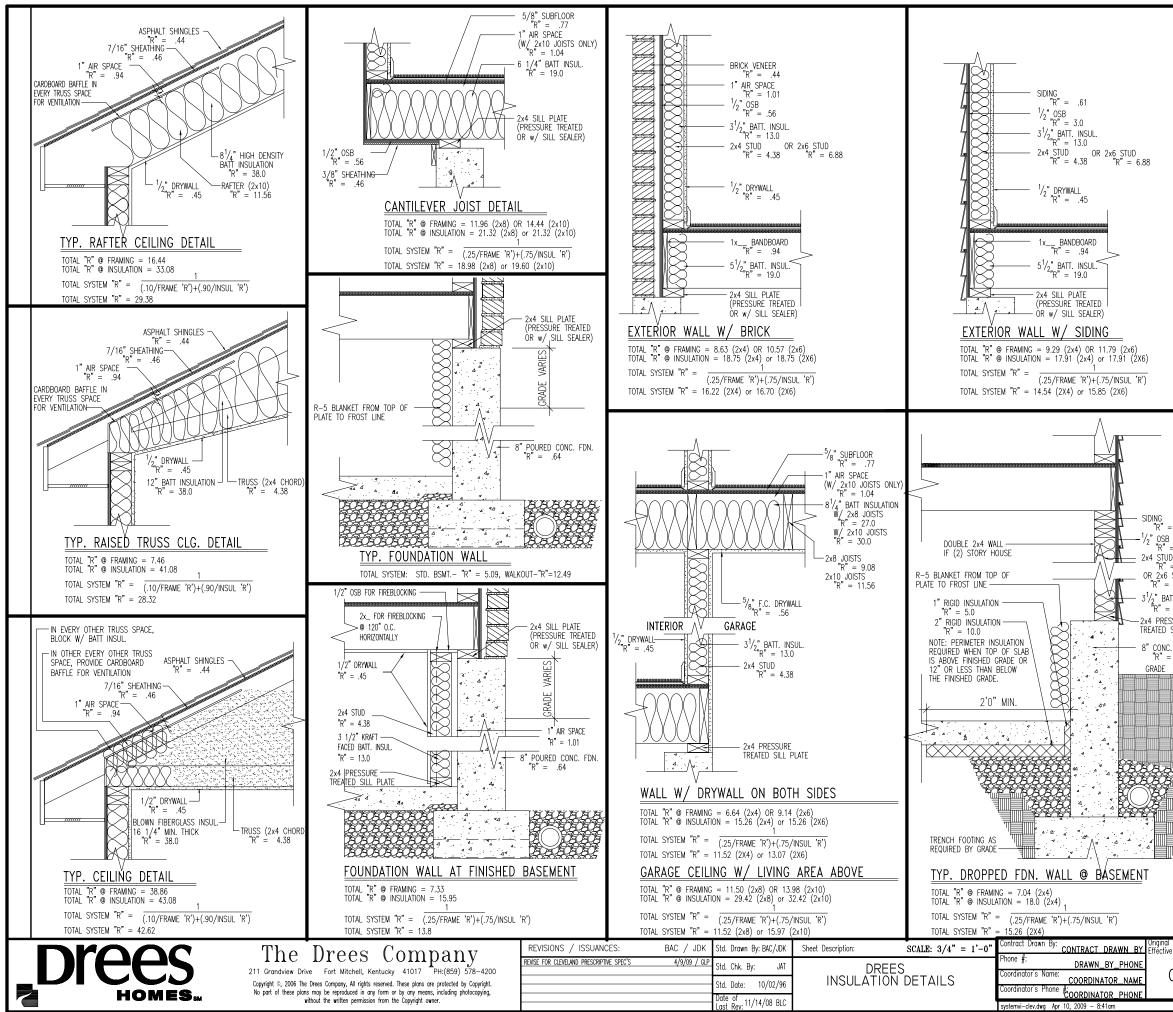
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| | ARDING TOTAL NOTES BUCHANAN MODEL MIDWEST DIVISION MID-WEST |
| | SD-1 |

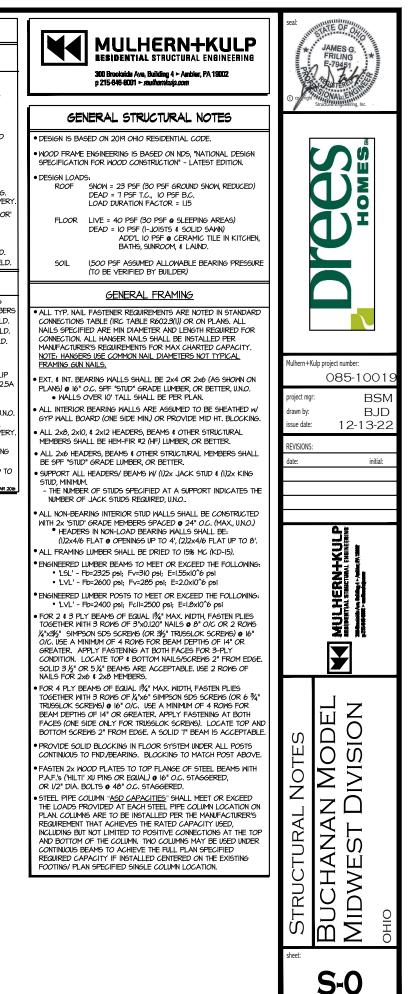REISSUED: 06/26/2023

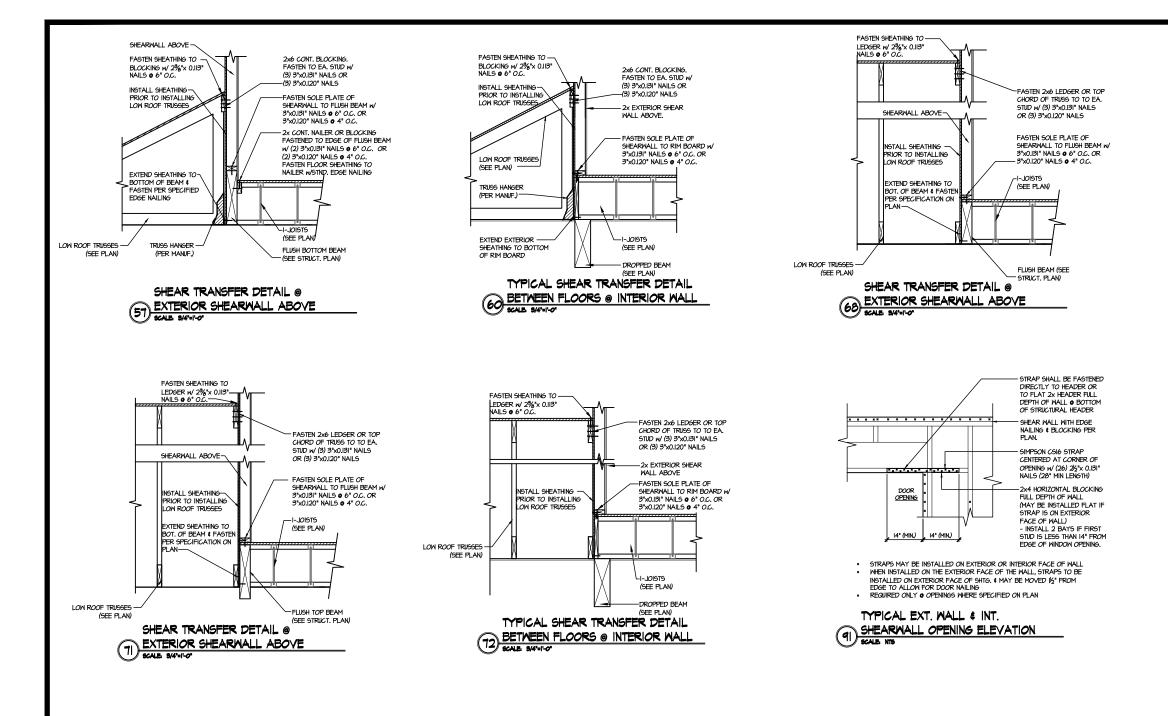



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| | Mulhern+Kulp project number: O85-10019 project ngr: BSM drawn by: BJD issue date: 12-13-22 PERKINIK: |
| | REVISIONS: date: initial: |
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| | BUCHANAN MODEL |


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| | ENERGY REQUIREMENTS |
|--|---|
| -AIR LEAKAGE | JOINTS, PENETRATIONS, AND ALL OTHER SUCH OPENINGS IN THE BUILDING ENVELOPE THAT |
| | ARE SOURCES OF AIR LEAKAGE MUST BE CAULED, GASKETED, WEITHE BUTLERDELINEO, OR ARE SOURCES OF AIR LEAKAGE MUST BE CAULED, GASKETED, WATHERSTRIPPED, OR OTHERWISE SEALED. THE MAXIMUM LEAKAGE RATE FOR MANUFACTURED WINDOWS IS 0.34 CFM/TF OF OPERABLE SASH CRACK. THE MANUFACTURED WINDOWS IS 0.34 CFM/TF OF OPERABLE SASH CRACK. THE MANUFACTURED AND A STATE MANUFACTURED DOORS IS 0.5 CFM/SQ.FT. OF DOOR AREA. |
| -VAPOR RETARDER | VAPOR RETARDERS MUST BE INSTALLED ON THE WARM-IN-WINTER SIDE OF ALL NON-VENTED FRAMED CELINGS, WALLS, AND FLOORS. THIS REQUIREMENT DOES NOT APPLY TO THE FOLLOWING LOCATIONS NOR WHERE MOISTER OR ITS FREEZING WILL NOT DAMAGE THE MATERIALS. |
| | TEXAS 20NES 2-5 ALABAMA, GEORGA, N.CAROLINA, OKLAHOMA, S.CAROLINA ZONES 4-6 ARKANSAS, TENNESSEE ZONES 6-7 FLORIDA, HAWAII, LOUISIANA, MISSISSIPPI ALL ZONES |
| -MATERIALS AND INSULATION INFORMATION | MATERIALS AND EQUIPMENT MUST BE IDENTIFIED SO THAT COMPLANCE CAN BE DETERMINED. MANUFACTURER MANUALS FOR ALL INSTALLED HEATING AND COOLING COUPMENT AND SERVICE WATER HEATING EQUIPMENT MUST BE PROVIDED. INSULATION R-VALUES, GLAZING AND DOOR U-VALUES, AND HEATING AND COOLING EQUIPMENT EFFICIENCY (IF HIGH-EFFICIENCY CREDIT IS TAKEN) MUST BE CLEARLY MARKED ON THE BUILDING PLANS OR SPECIFICATIONS. |
| -DUCT INSULATION | SUPPLY AND RETURN DUCTS FOR HEATING AND COOLING SYSTEMS LOCATED IN UNCONDITIONED SPACES MUST BE INSULATED TO THE LEVELS SHOWN BELOW. |
| | EXCEPTIONS: INSULATION IS NOT REQUIRED FOR EXHAUST AIR DUCTS, DUCTS WITHIN HVAC EQUIPMENT, AND WHEN THE DESIGN TEMPERATURE DIFFERENCE BETWEEN THE AIR IN THE DUCT AND THE SURROUNDING AIR IS 25' OR LESS. |
| -DUCT CONSTRUCTION | ALL TRANSVERSE JOINTS MUST BE SEALED WITH MASTIC, TAPE, OR MASTIC PLUS TAPE. THE HVAC SYSTEM MUST PROVIDE A MEANS FOR BALANCING AIR AND WATER SYSTEMS. |
| -TEMPERATURE CONTROLS | THERMOSTATS ARE REQUIRED FOR EACH SEPERATE HVAC SYSTEMS IN SINGLE-FAMILY BUILDINGS AND EACH DWELLING UNIT IN MULTIFAMILY BUILDINGS (NON-DWELLING PORTIONS OF MULTIFAMILY BUILDINGS MUST HAVE ONE THERMOSTAT FOR EACH SYSTEM OF ZONE). THERMOSTATS MUST HAVE THE FOLLOWING RAVGES: HEATING ONLY 55F - 75F COOLING ONLY 70F - 85F HEATING AND COOLING 55F - 85F |
| | A MANUAL OR AUTOMATIC MEANS TO PARTIALLY RESTRICT OR SHUT OFF THE HEATING AND/OR COOLING INPUT TO EACH ZONE OR FLOOR SHALL BE PROVIDED FOR SINGLE-FAMILY HOMES AND TO EACH ROOM FOR MULTIFAMILY BUILDINGS. |
| -HVAC PIPING INSULATION | HVAC PIPING IN UNCONDITIONED SPACES CONVEYING FLUIDS AT TEMPERATURES ABOVE 120'F OR CHILLED FLUIDS AT LESS THAN 55'F MUST BE INSULATED TO THE LEVELS SHOWN BELOW. |
| -ELECTRIC SYSTEMS | EACH MULTIFAMILY DWELLING UNIT MUST BE EQUIPPED WITH SEPERATE ELECTRIC MEANS. |
| = .61 = .56 D = 4.38 STUD 6.88 TT. INSUL. = .30 SSURE SILL PLATE : FDN. = .64 | <section-header></section-header> |
| Site Specific Dwg. & | |
| e Change Order Date: | Subdivision: SUB_NM Sheet No. |
| CONTRACT_DATE | |
| | Job Address: JOB_AD |

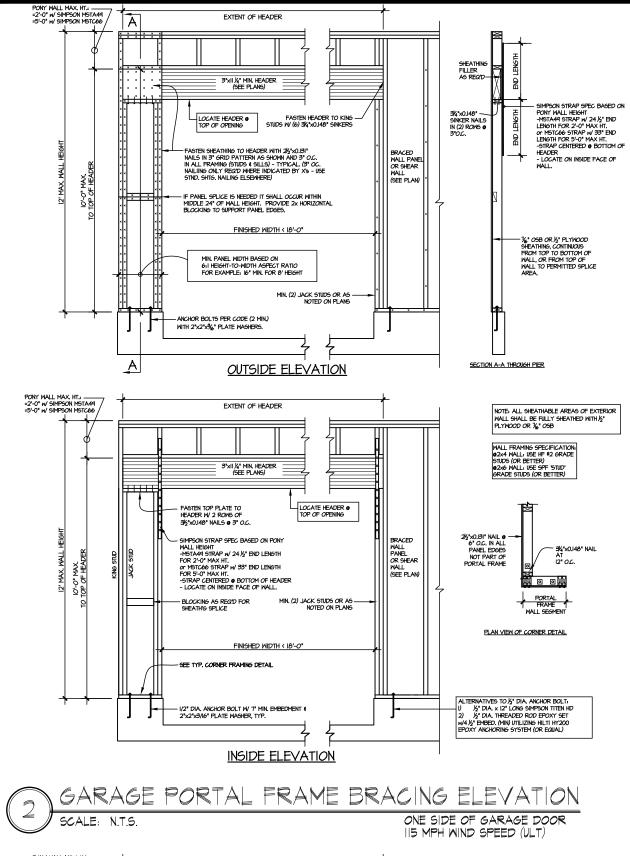




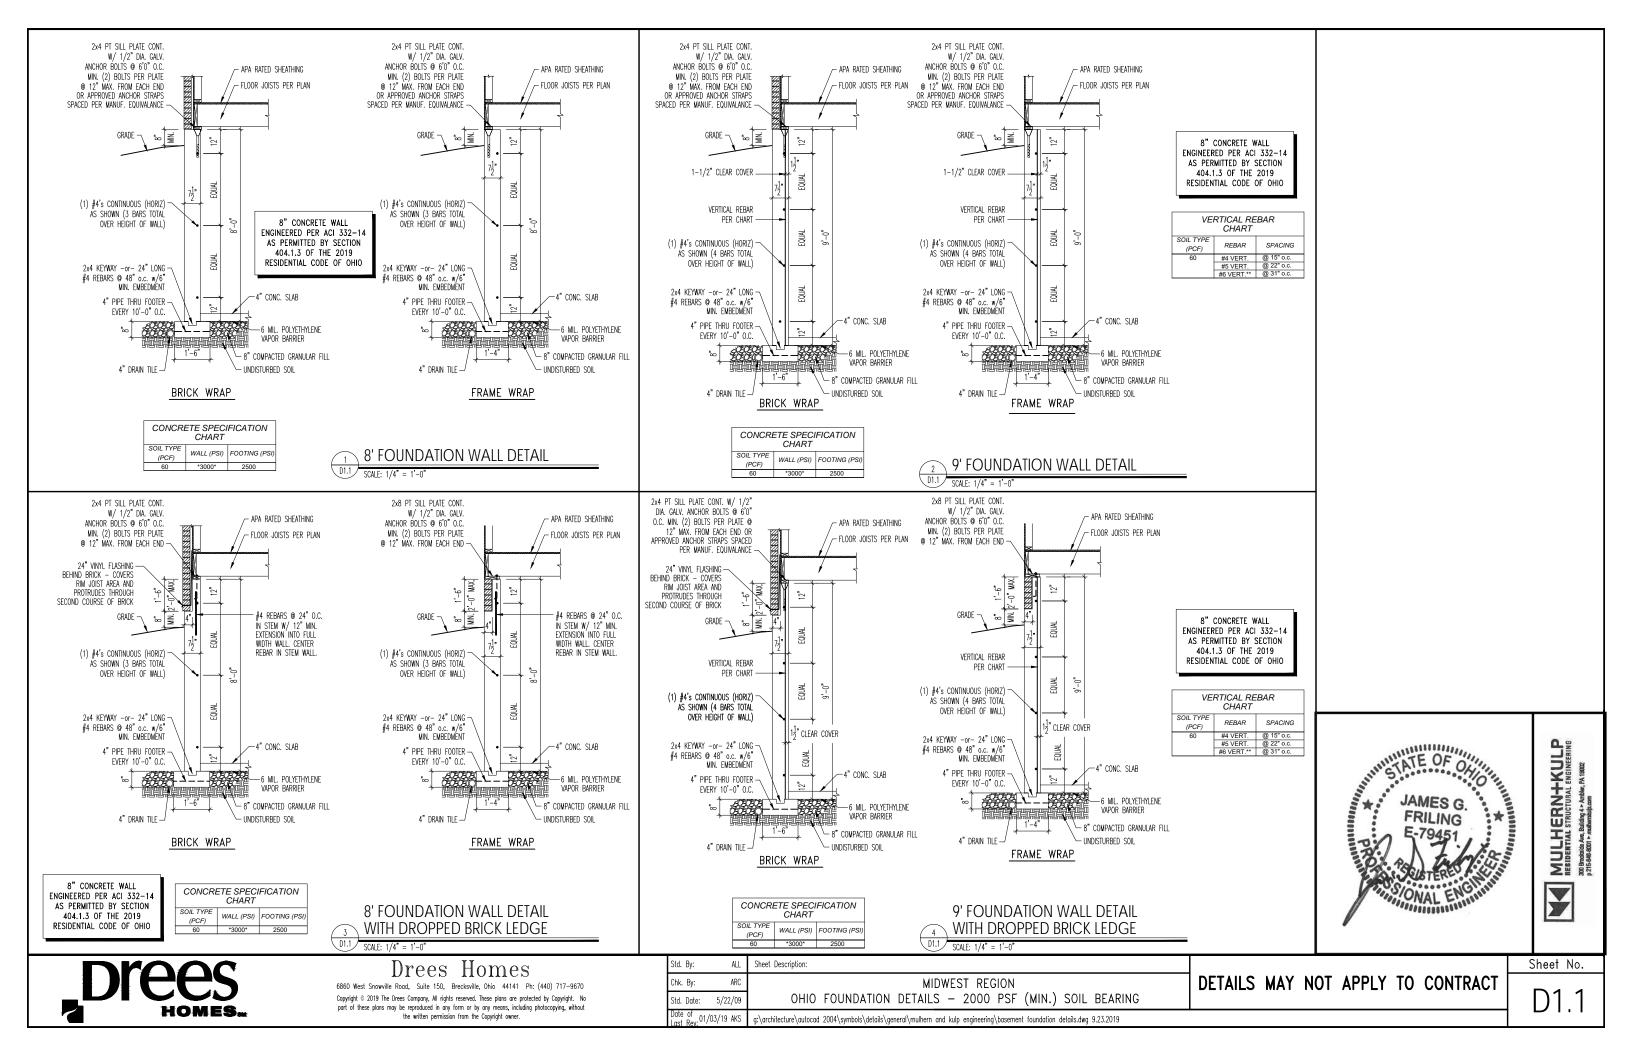


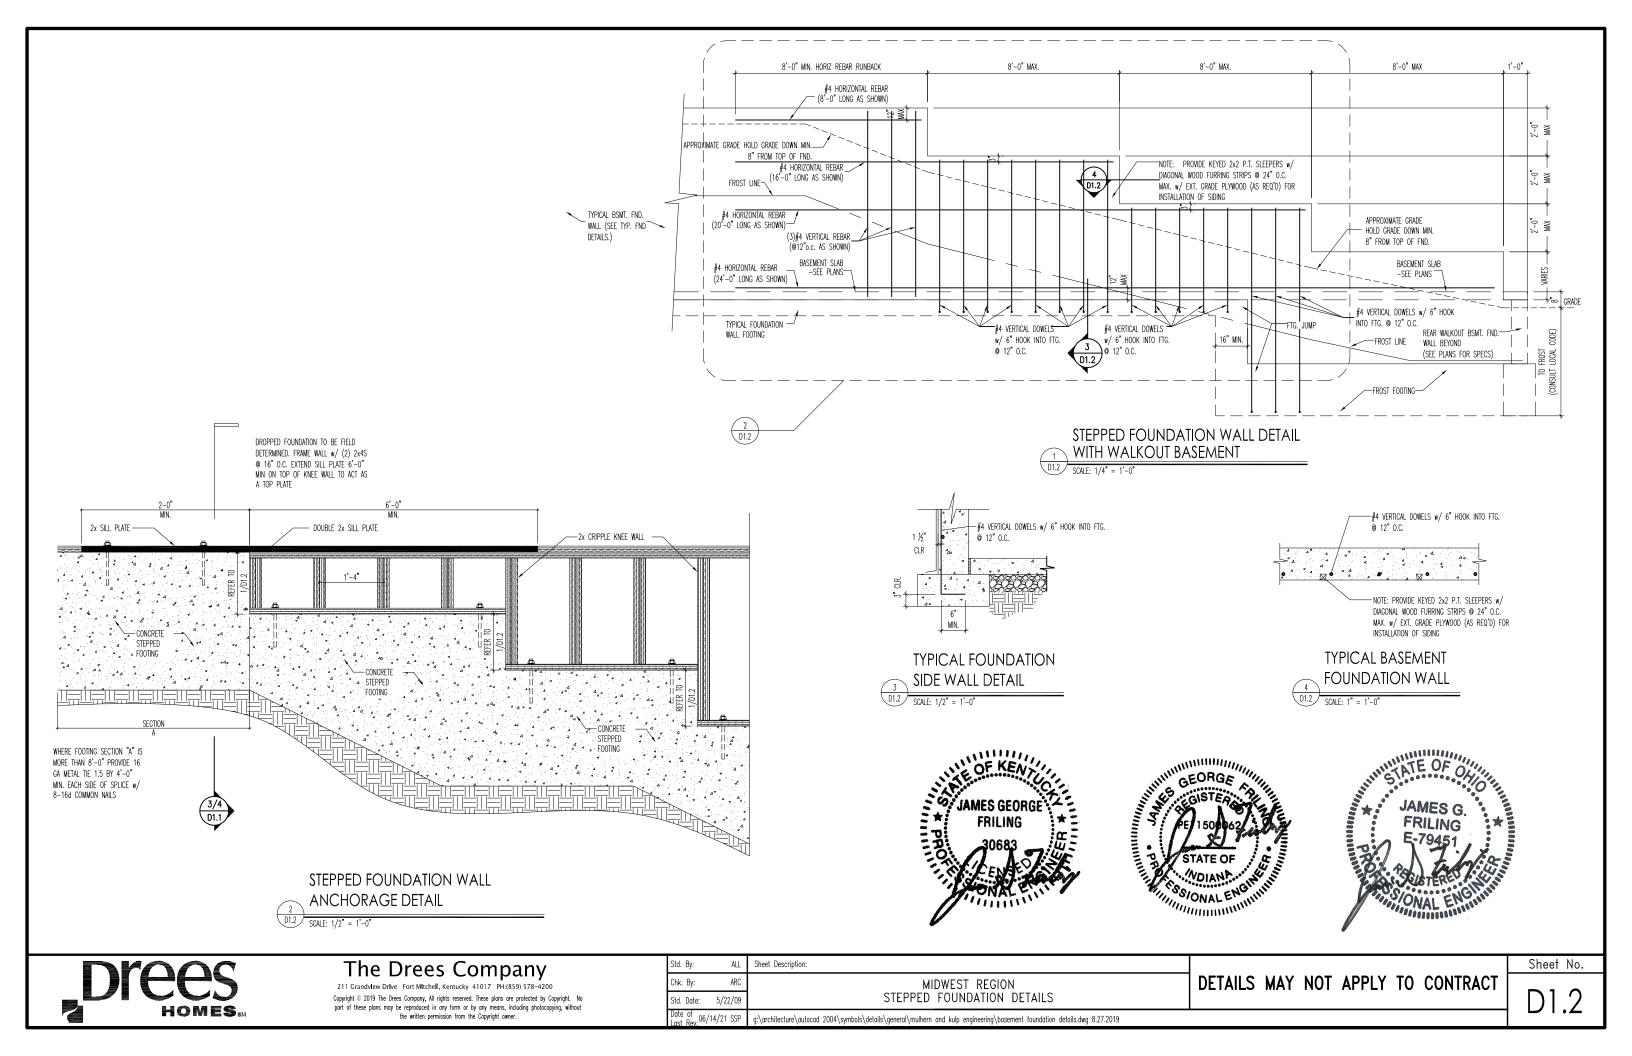
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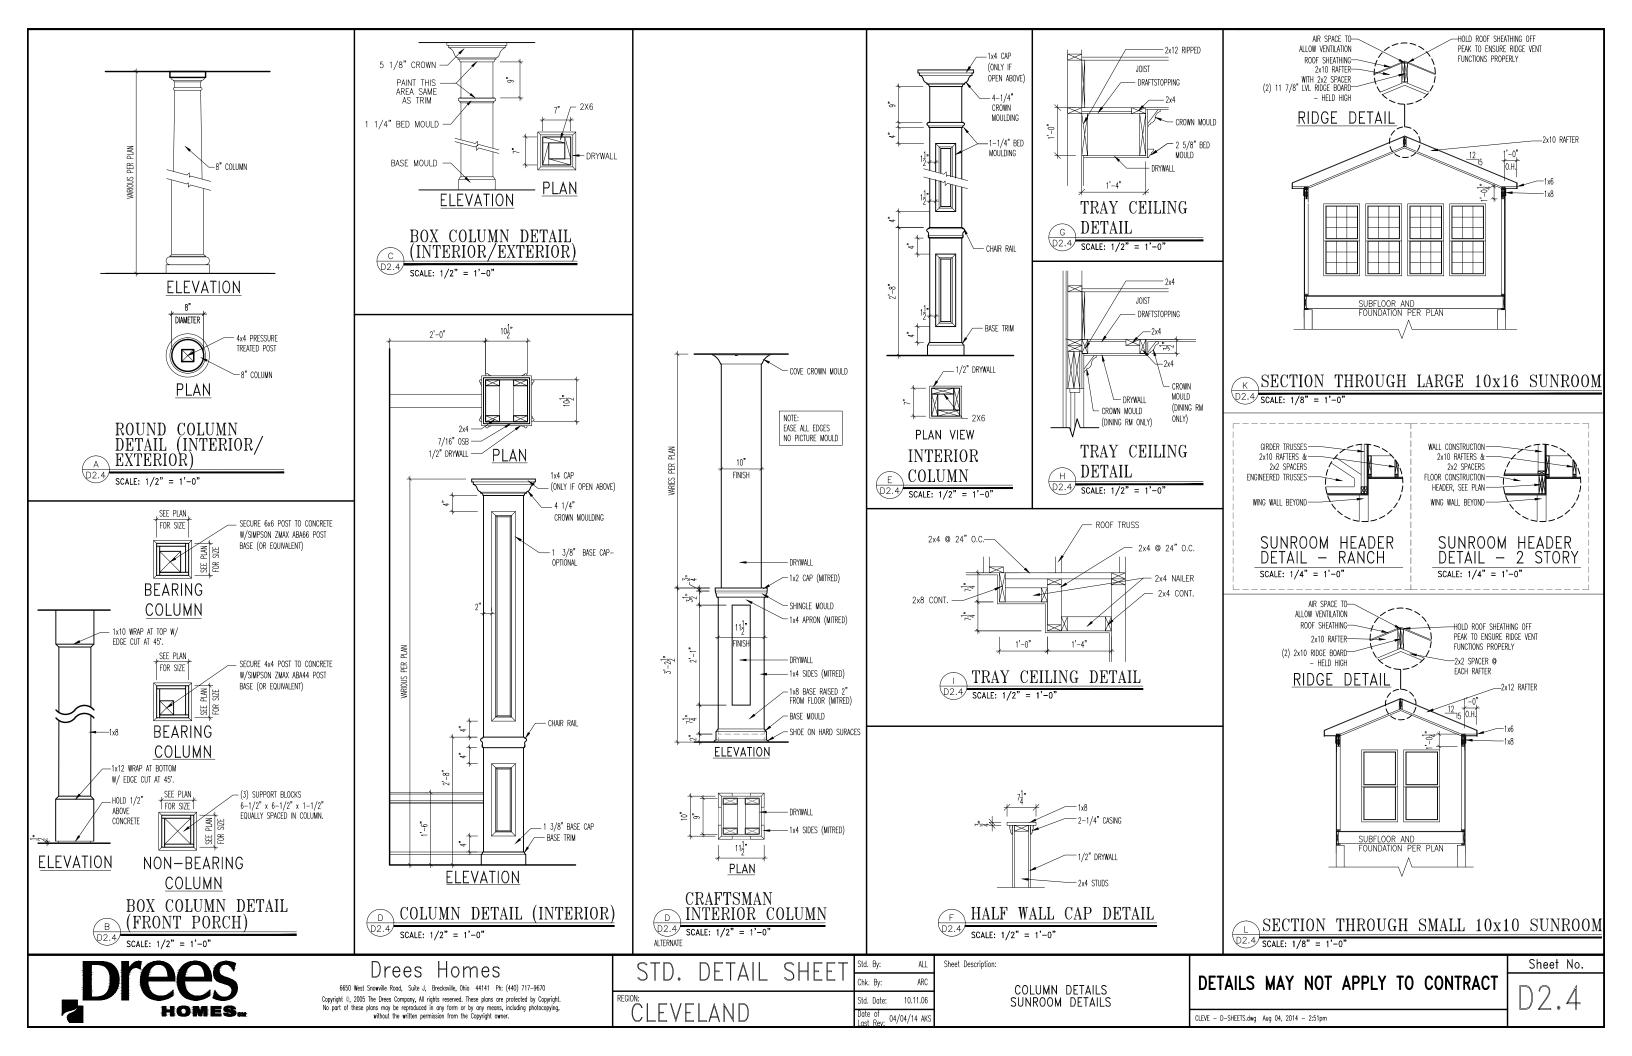
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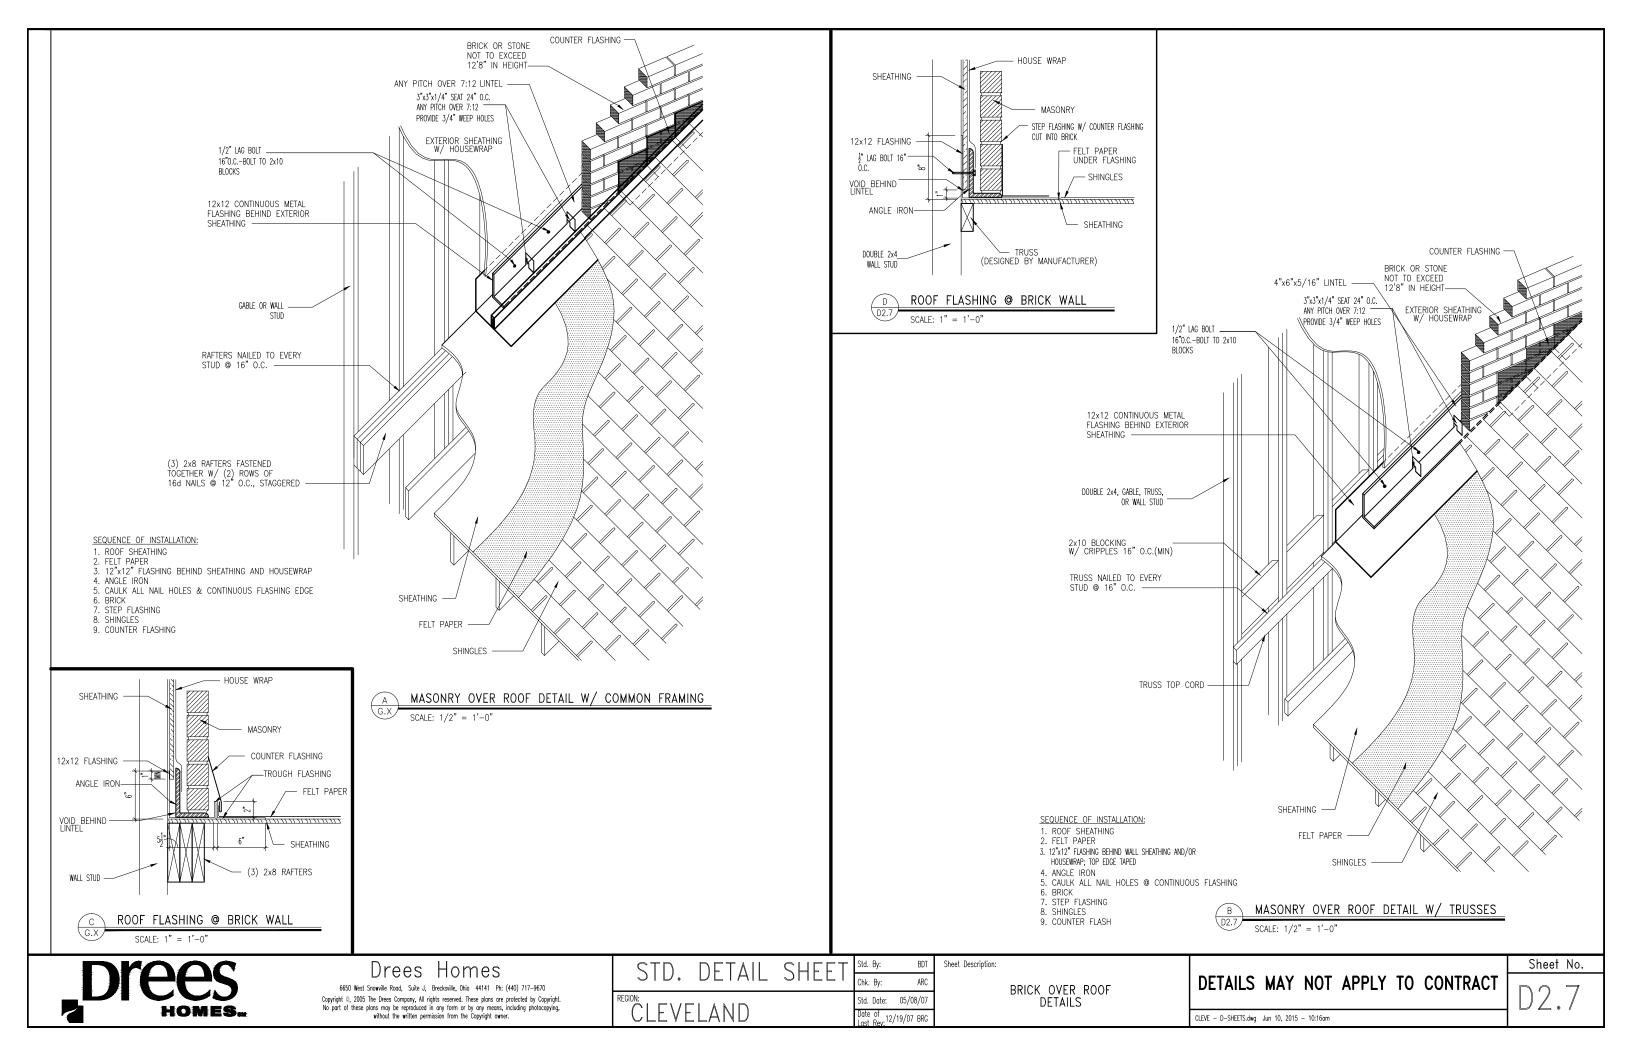
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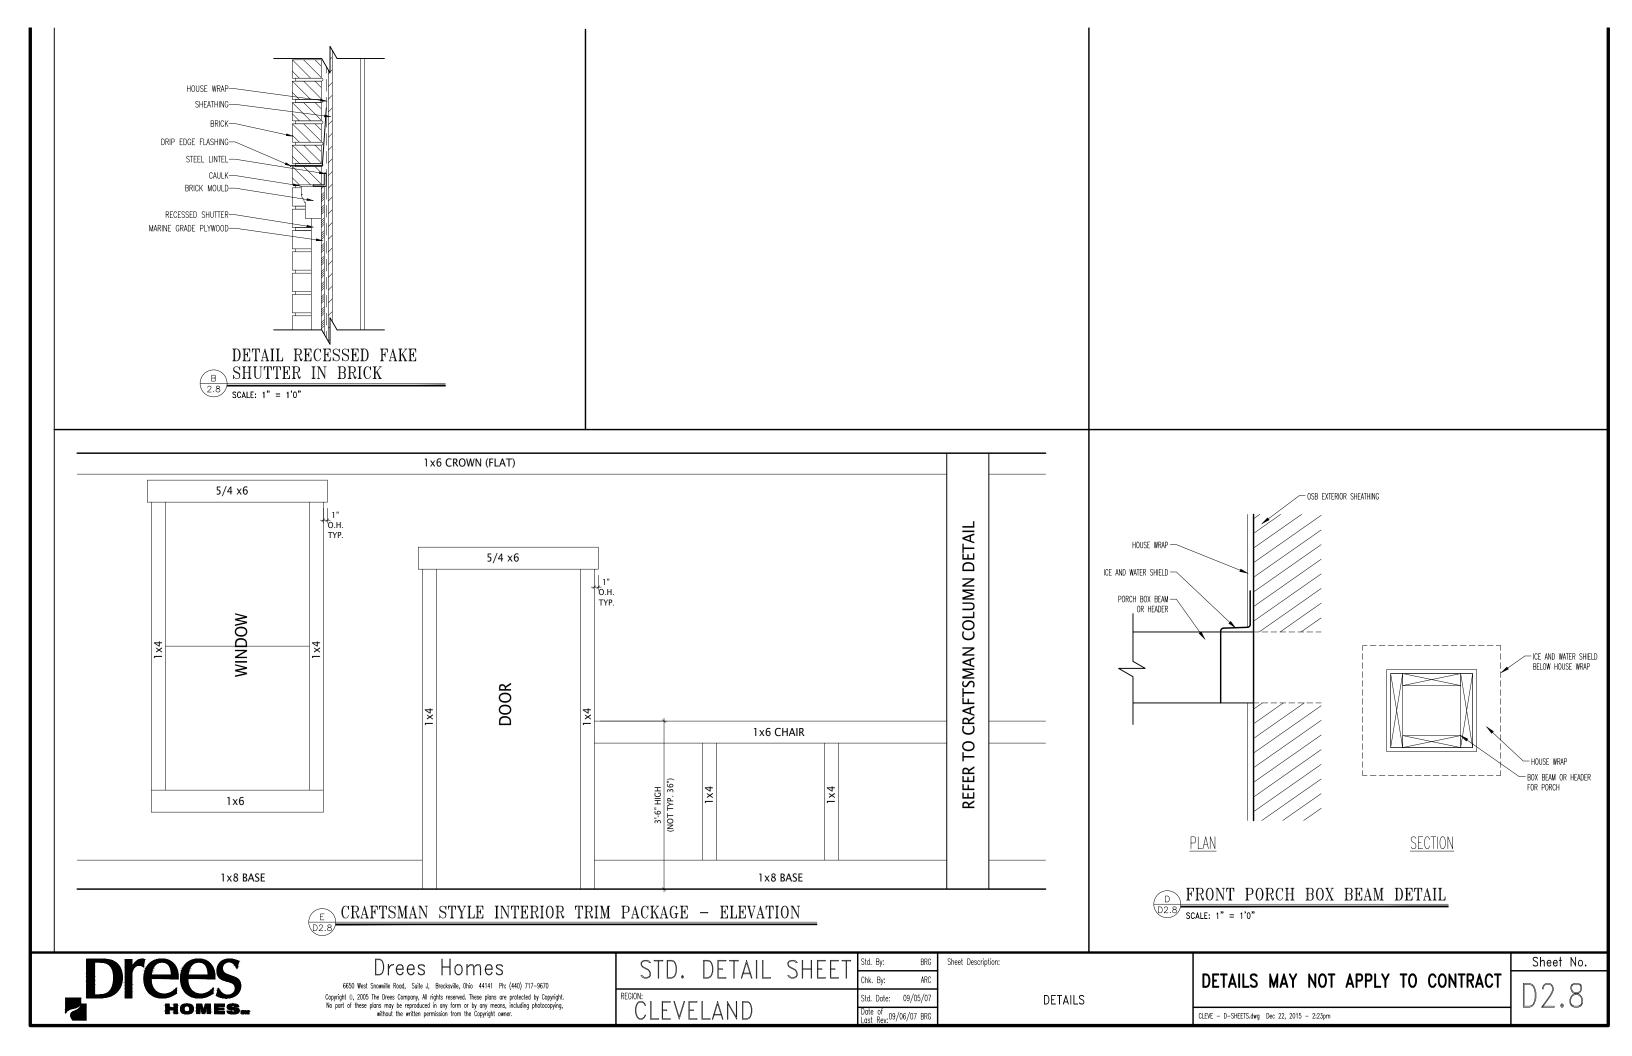


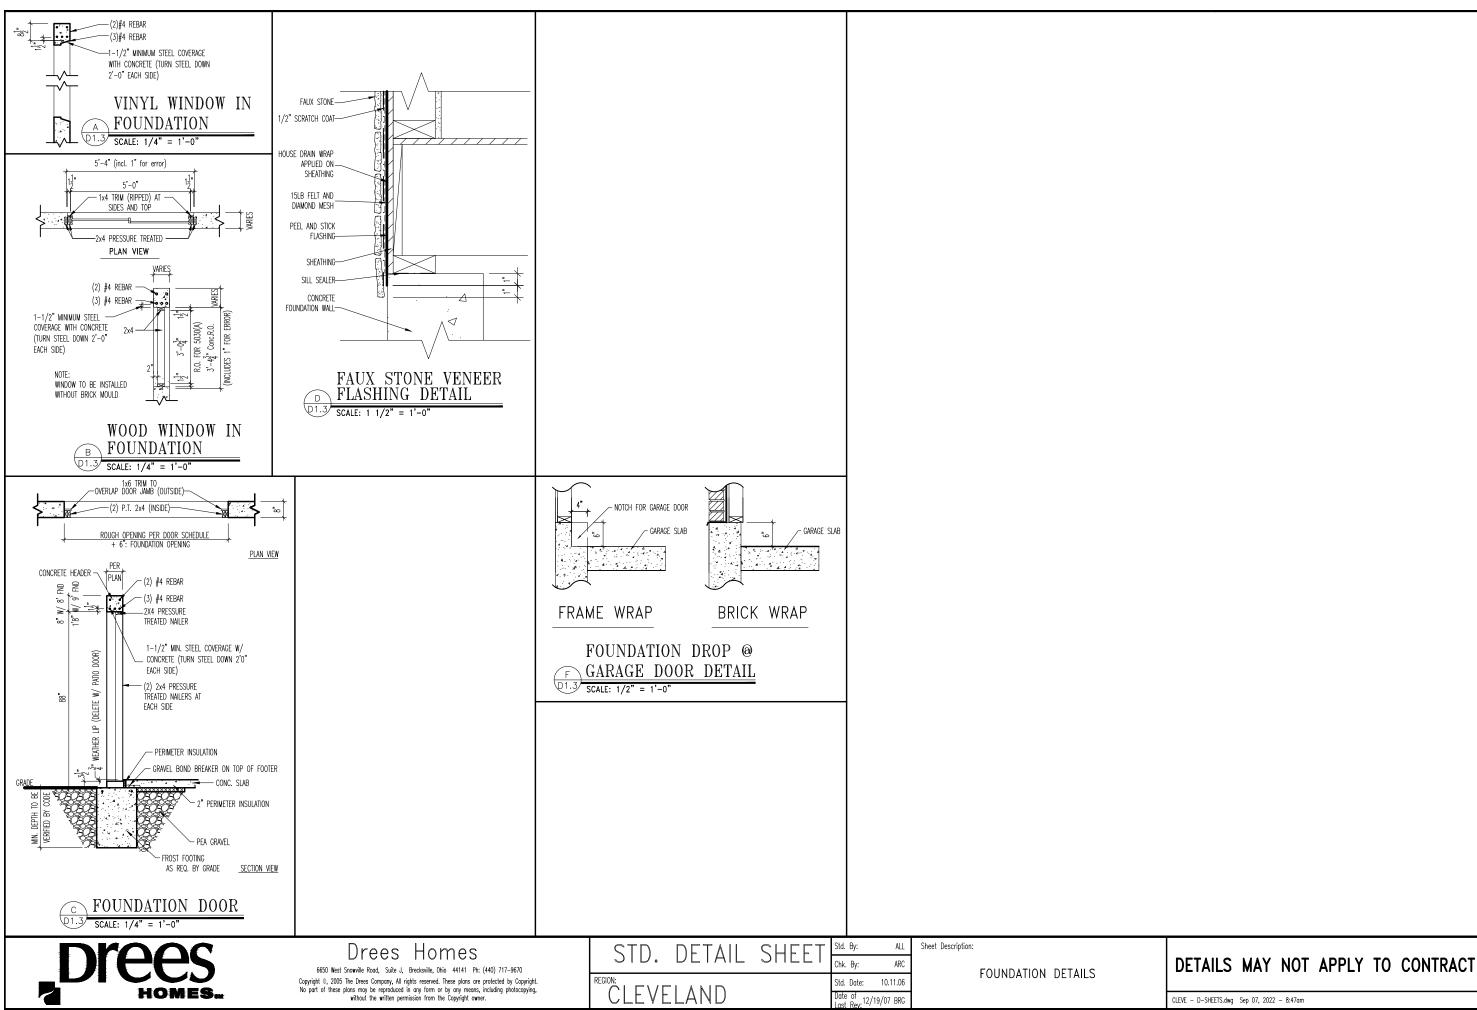





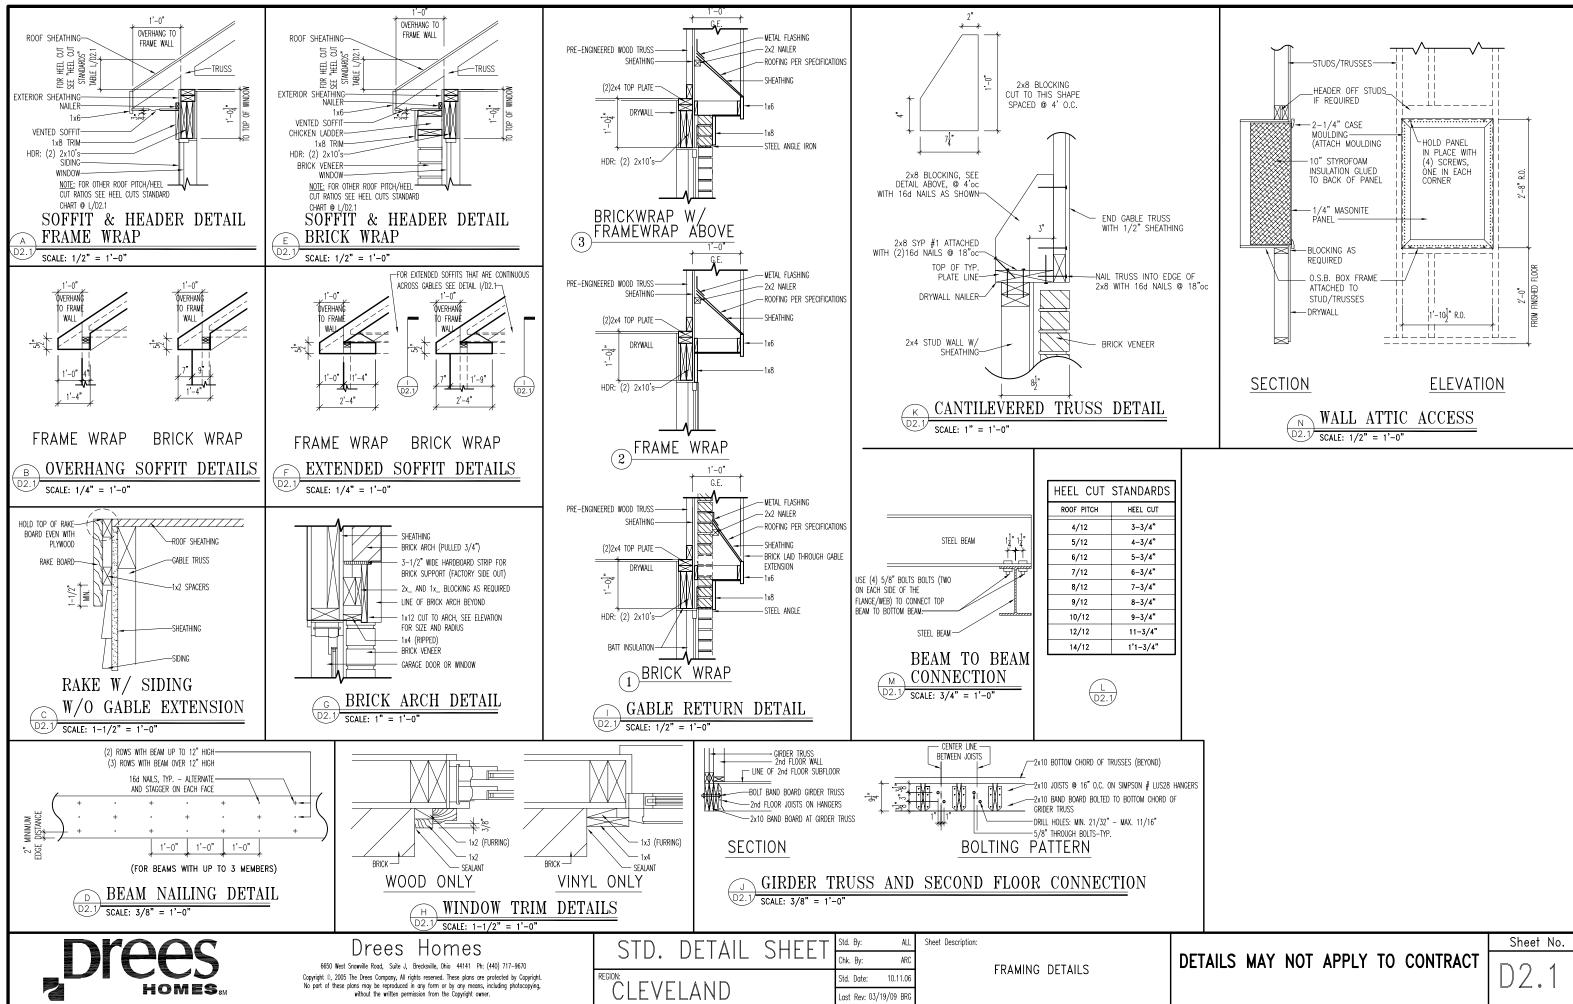


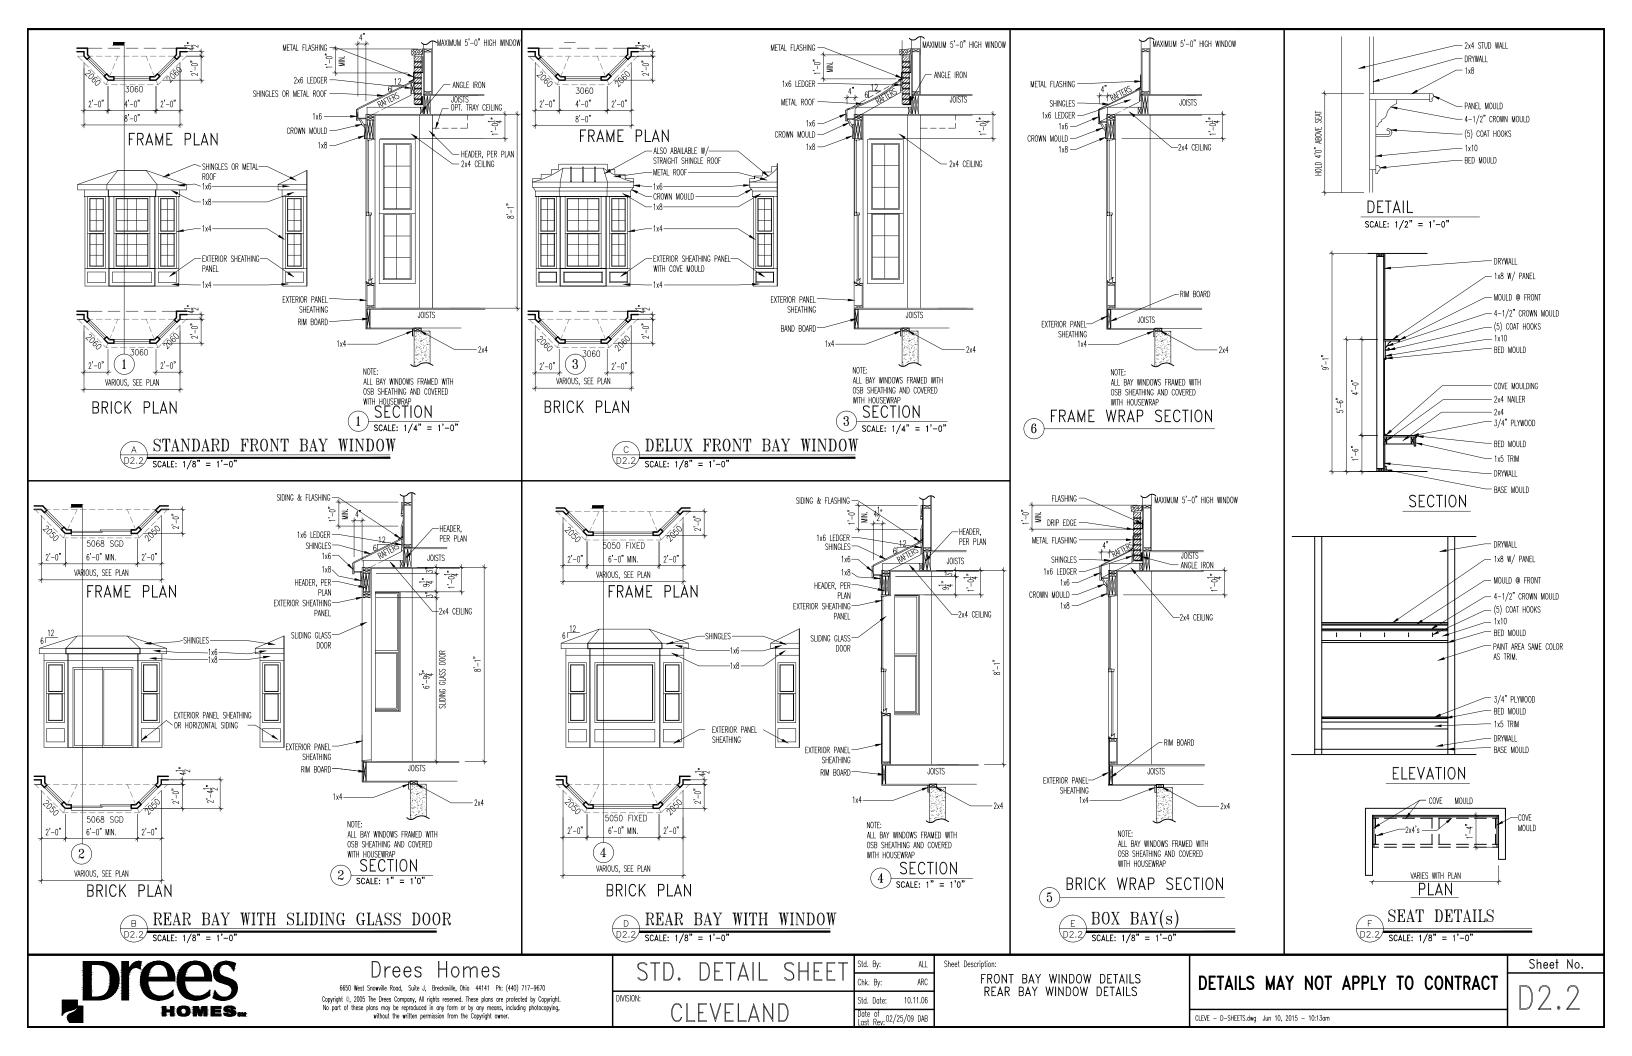


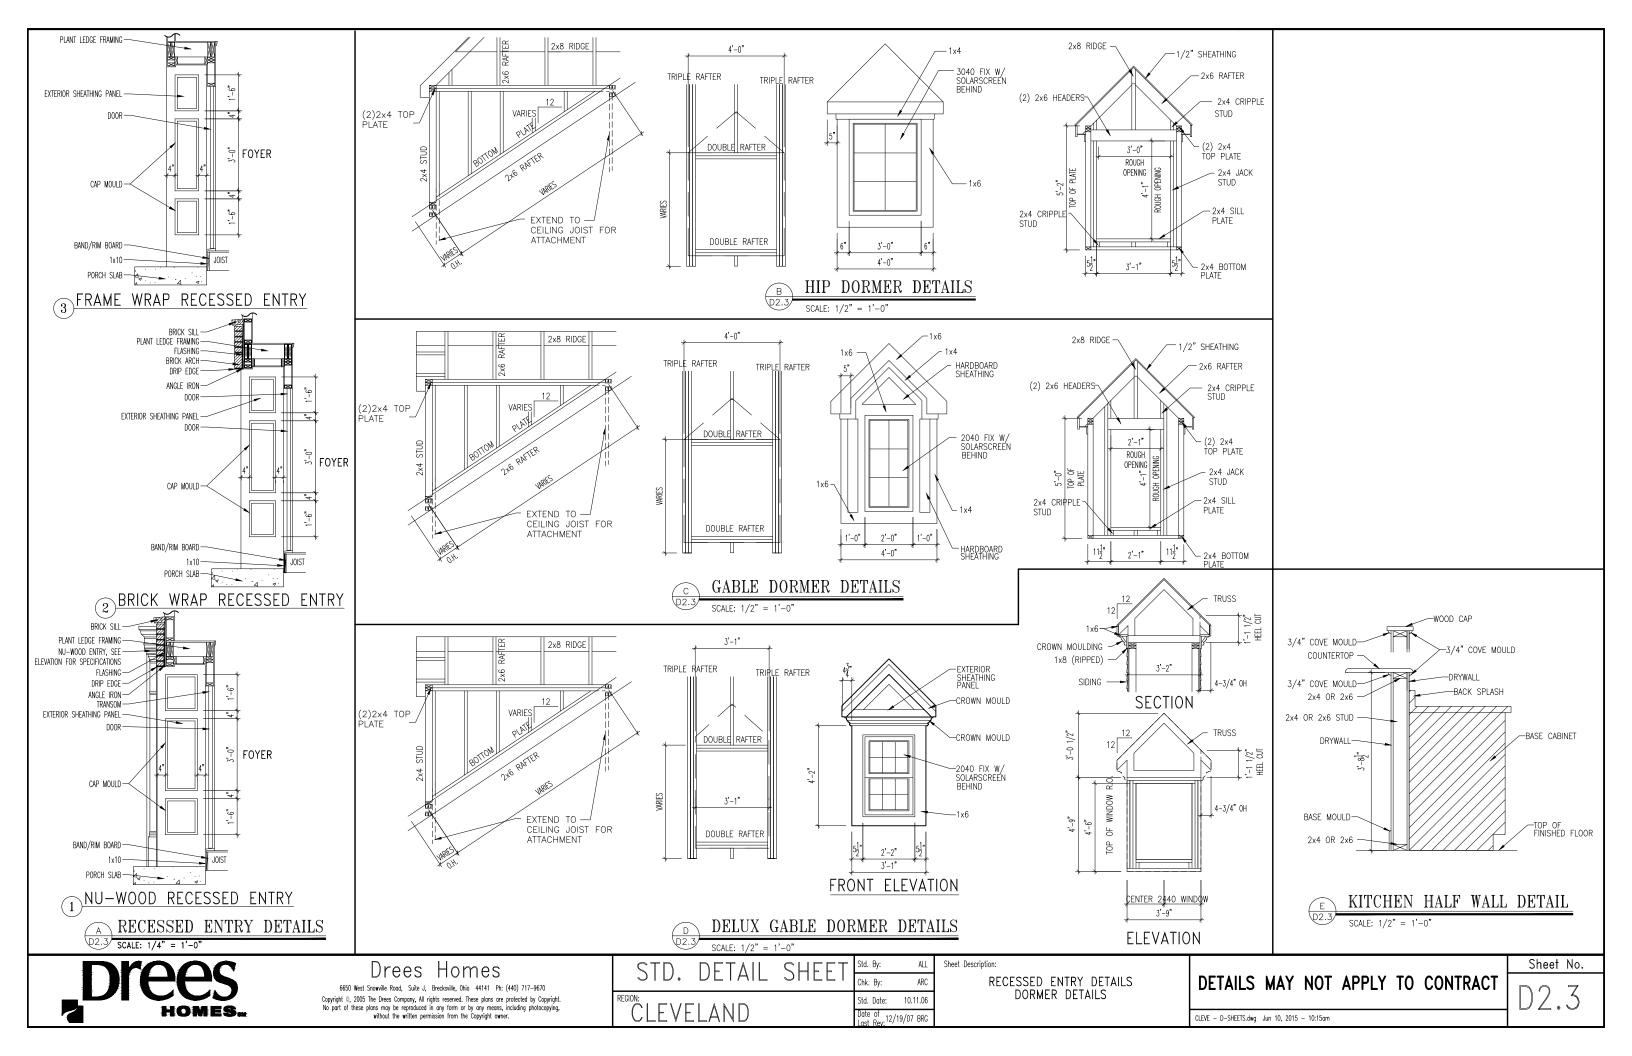

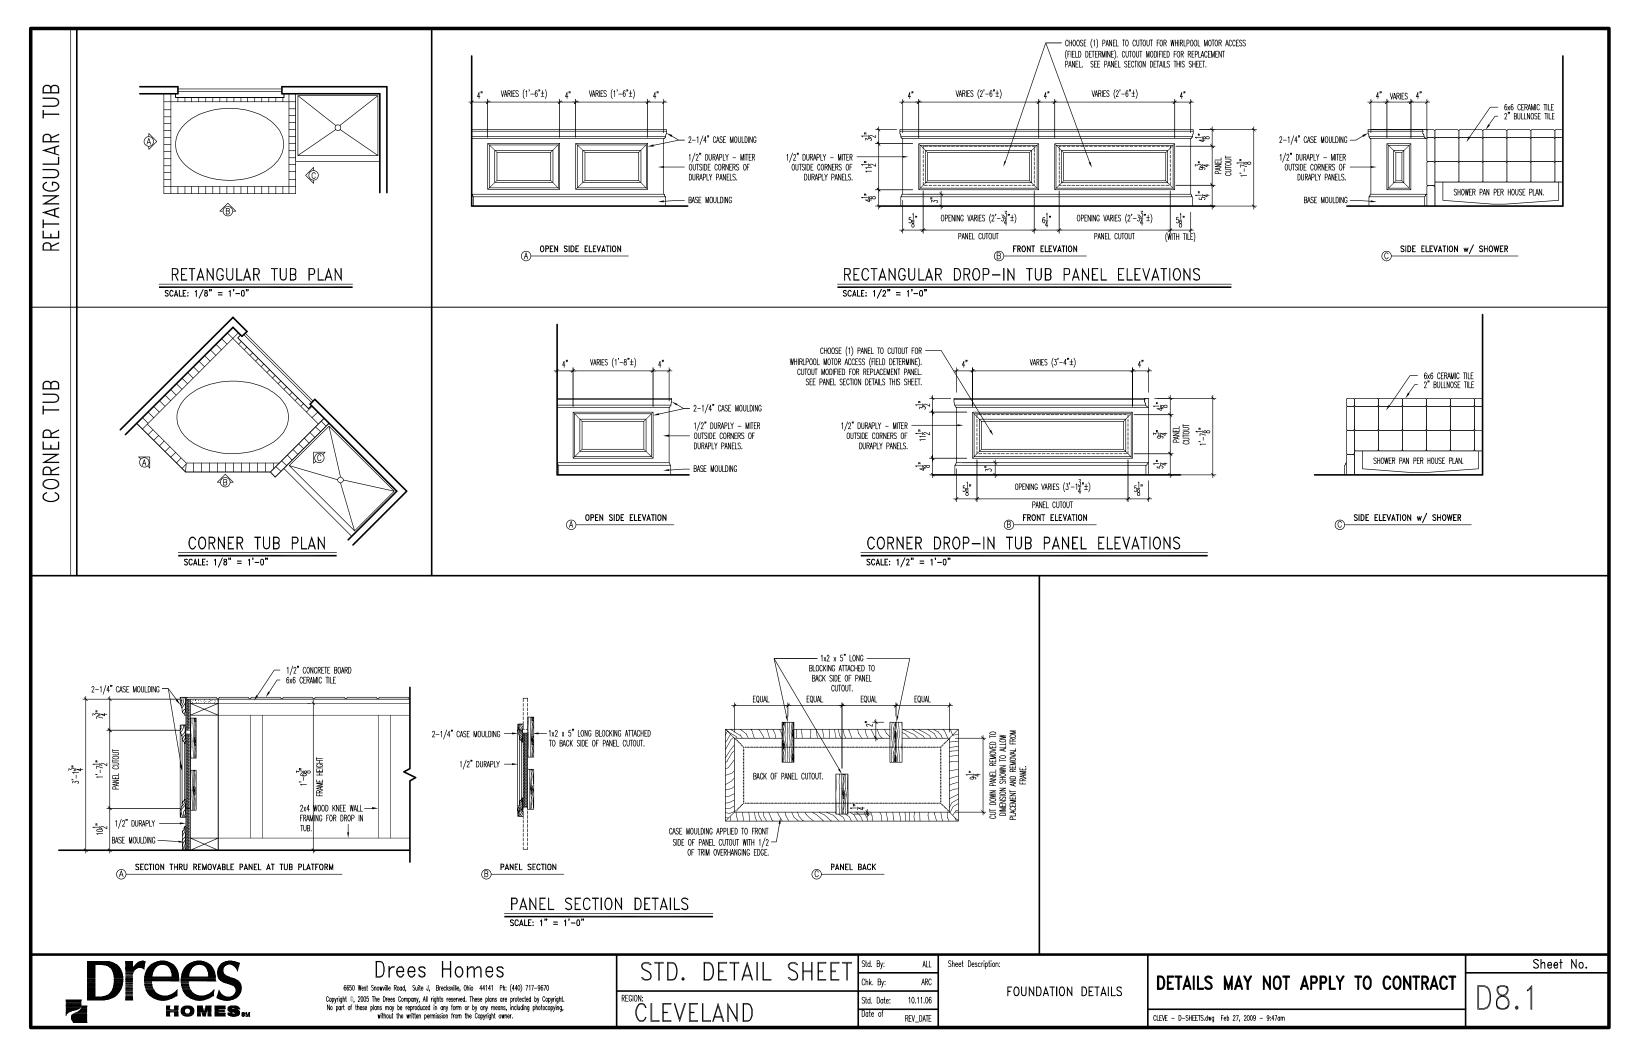

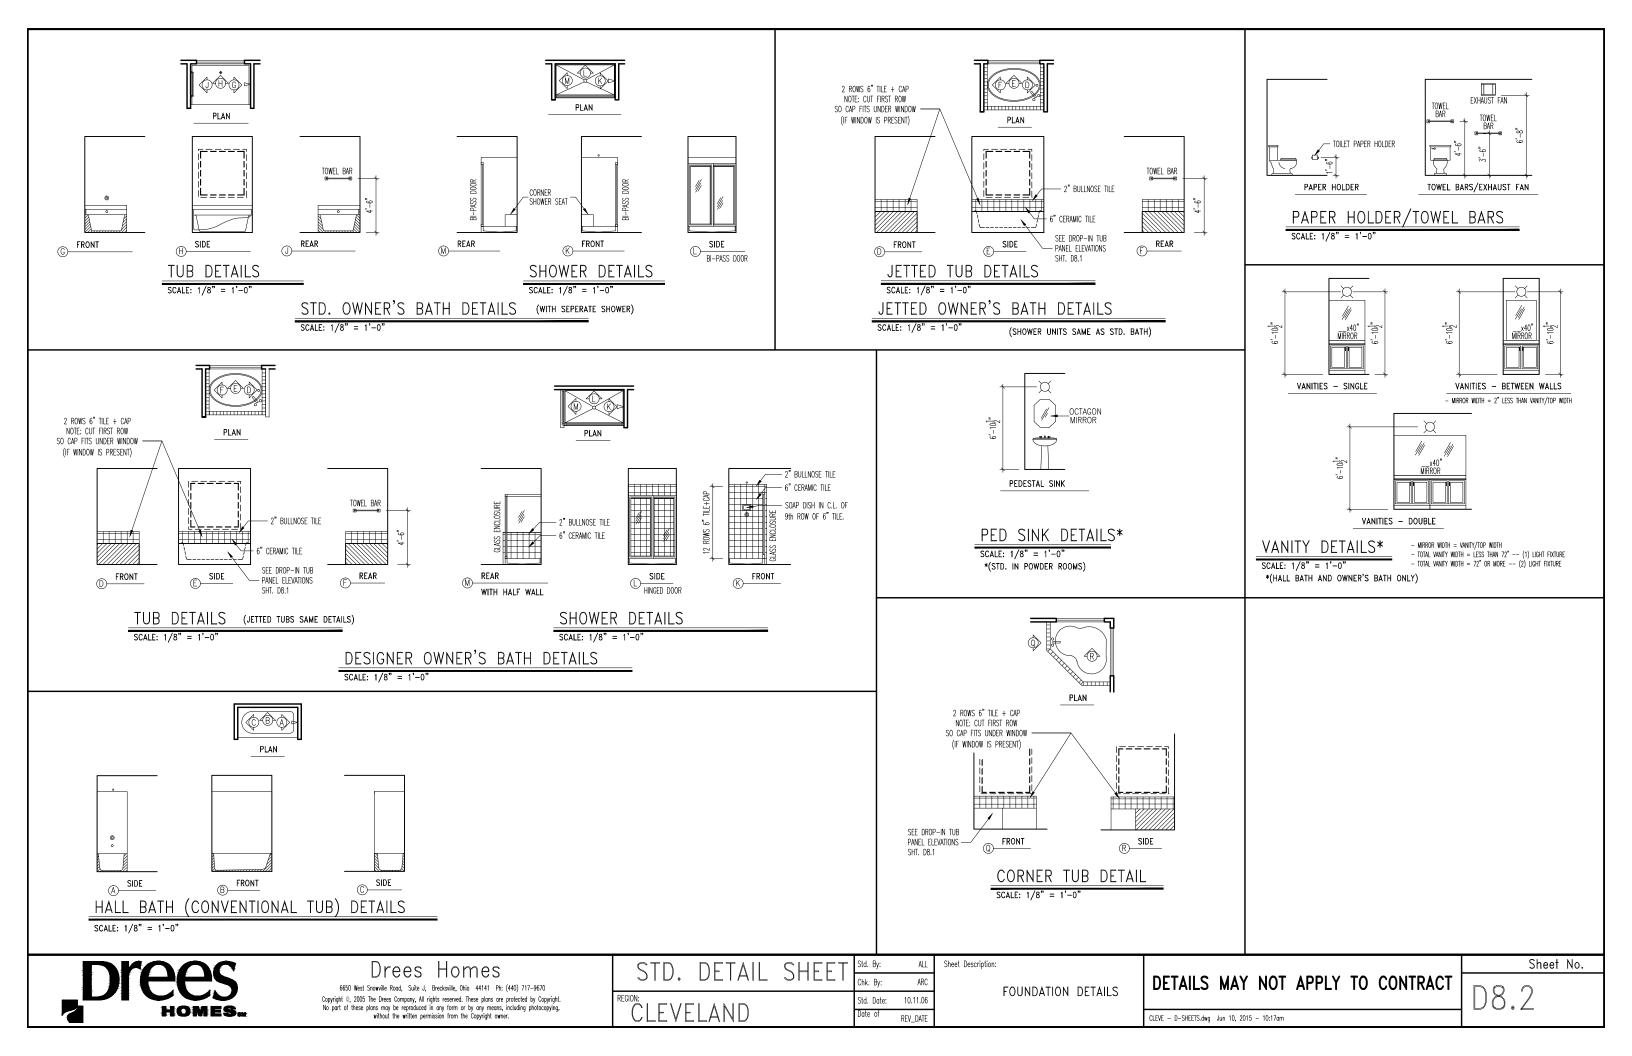

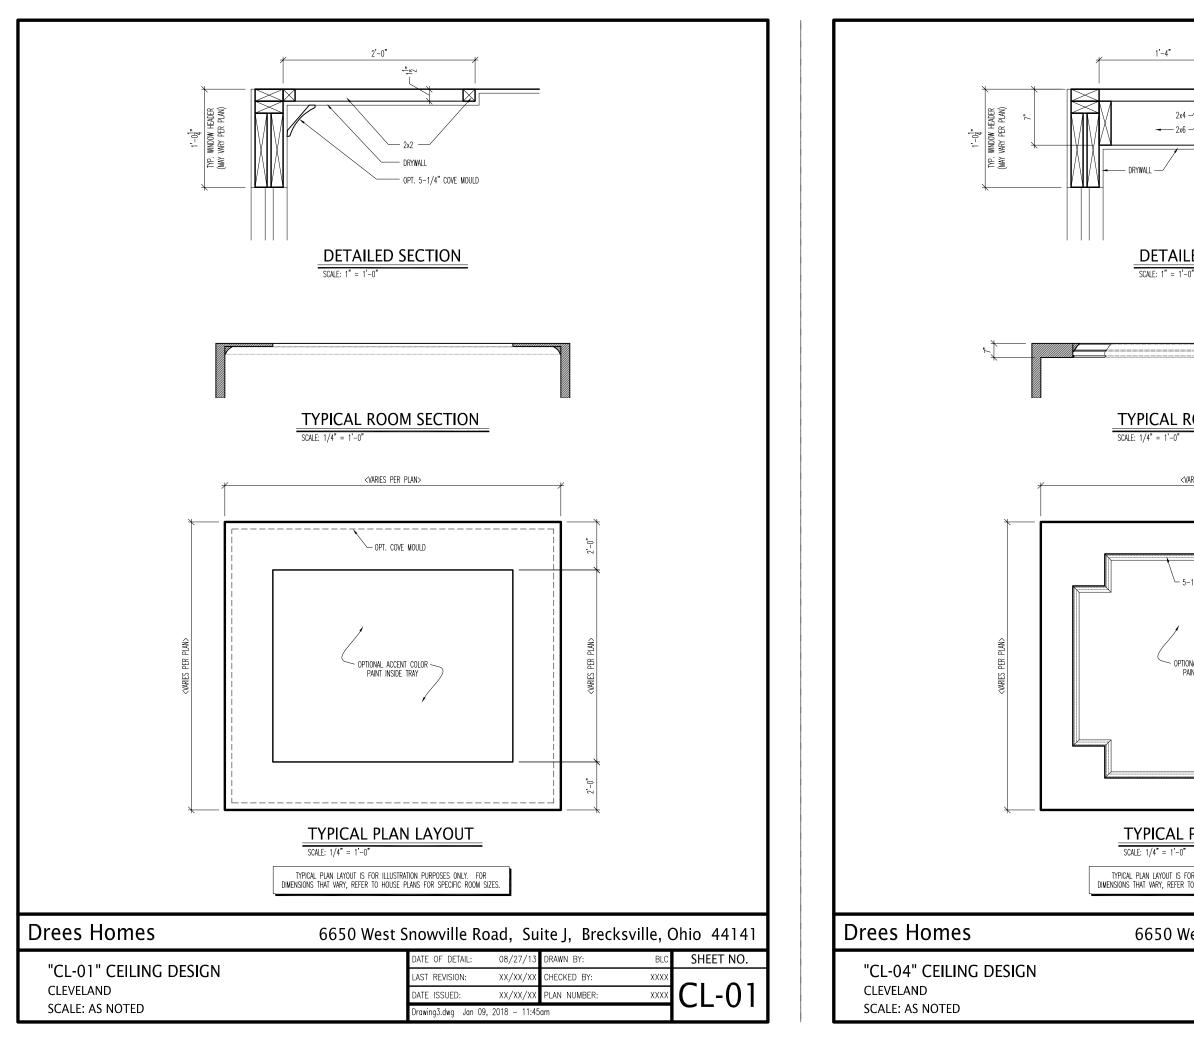


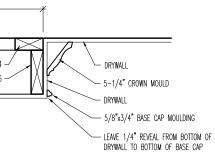

DETAILED SECTION



TYPICAL ROOM SECTION

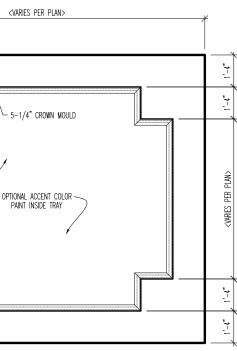



TYPICAL PLAN LAYOUT


TYPICAL PLAN LAYOUT IS FOR ILLUSTRATION PURPOSES ONLY. FOR DIMENSIONS THAT VARY, REFER TO HOUSE PLANS FOR SPECIFIC ROOM SIZES.

6650 West Snowville Road, Suite J, Brecksville, Ohio 44141

| DATE OF DETAIL: | 08/27/13 | DRAWN BY: | BLC | SHEET NO. |
|----------------------|--------------|--------------|------|-----------|
| LAST REVISION: | XX/XX/XX | CHECKED BY: | XXXX | |
| DATE ISSUED: | XX/XX/XX | PLAN NUMBER: | XXXX | CI-()4 |
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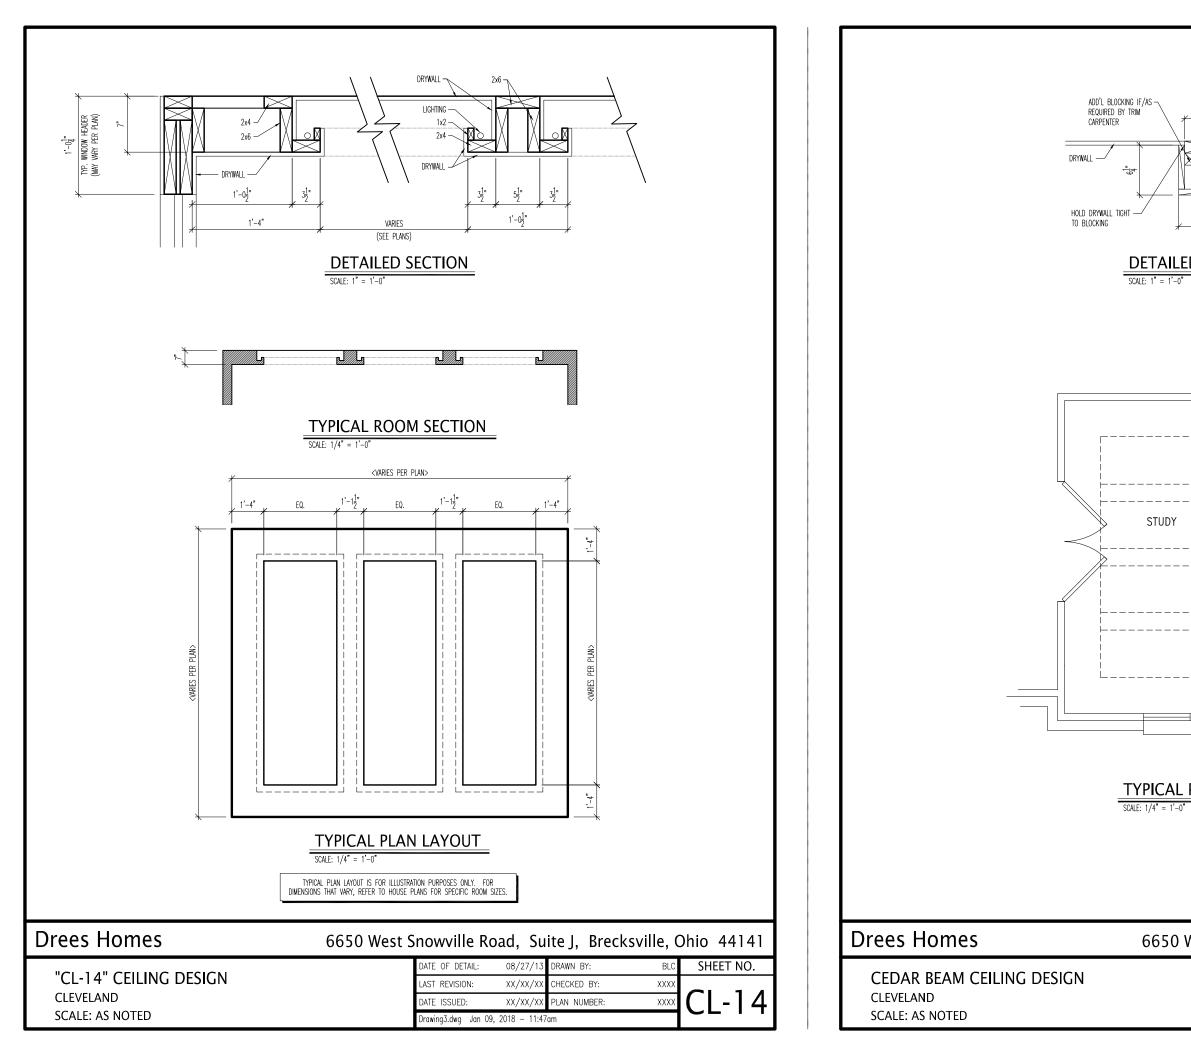


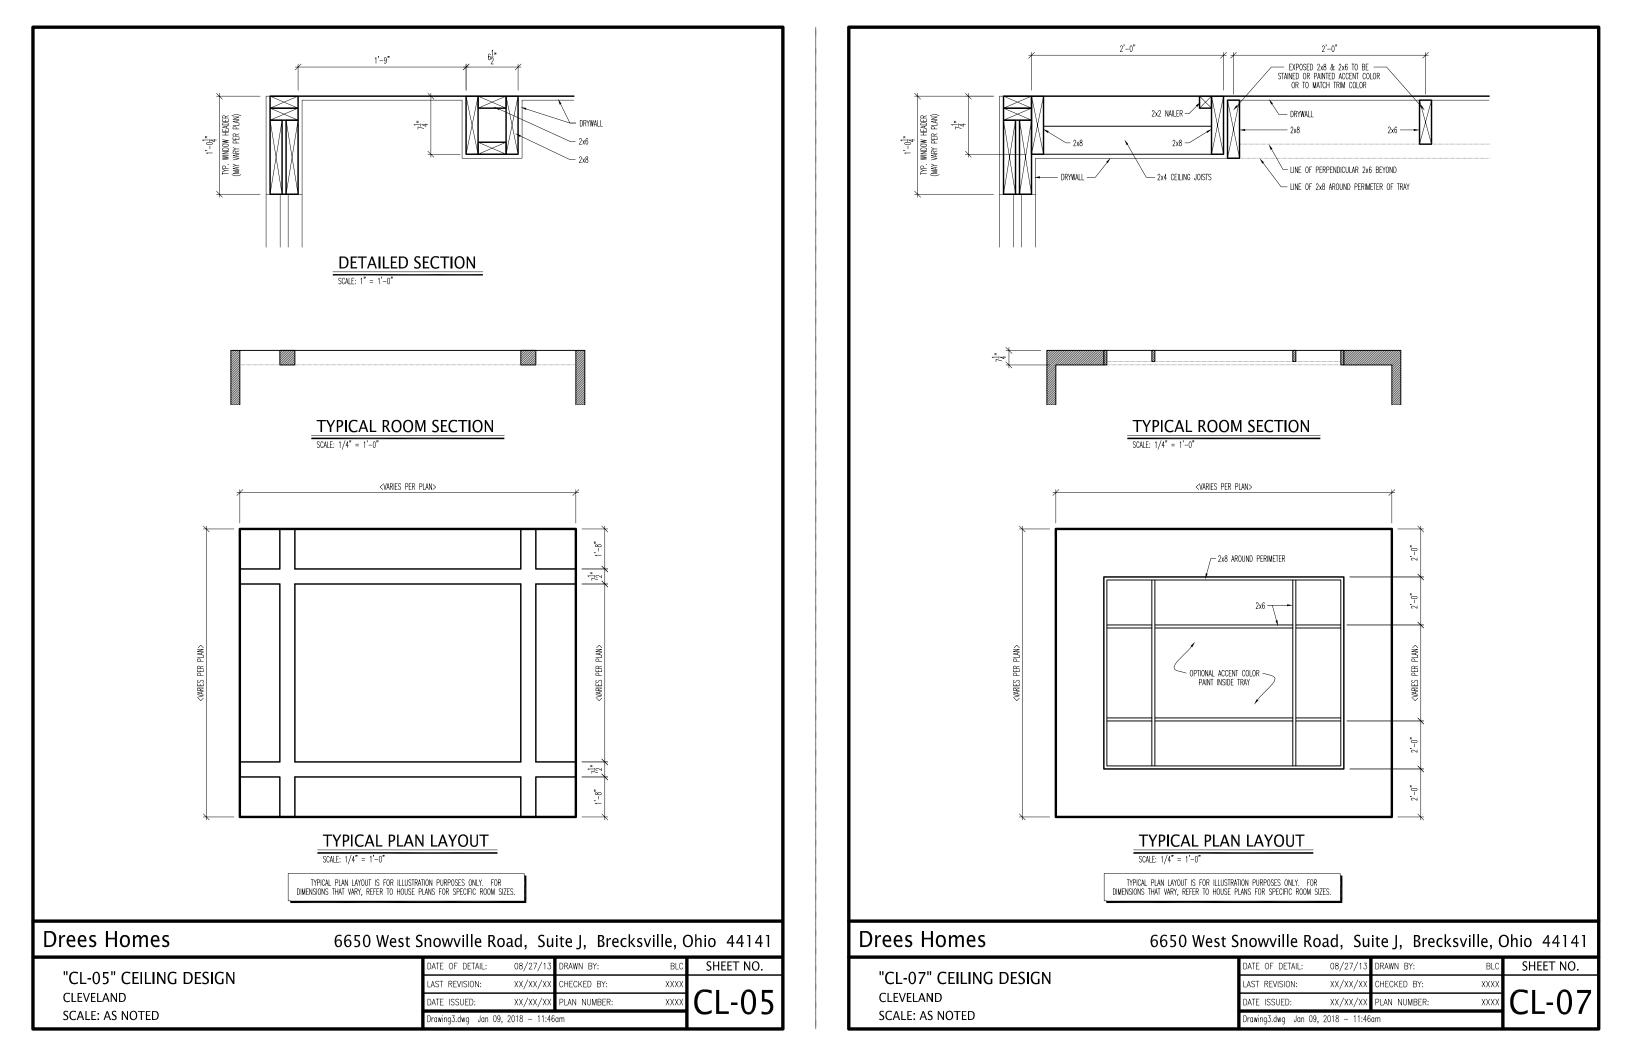


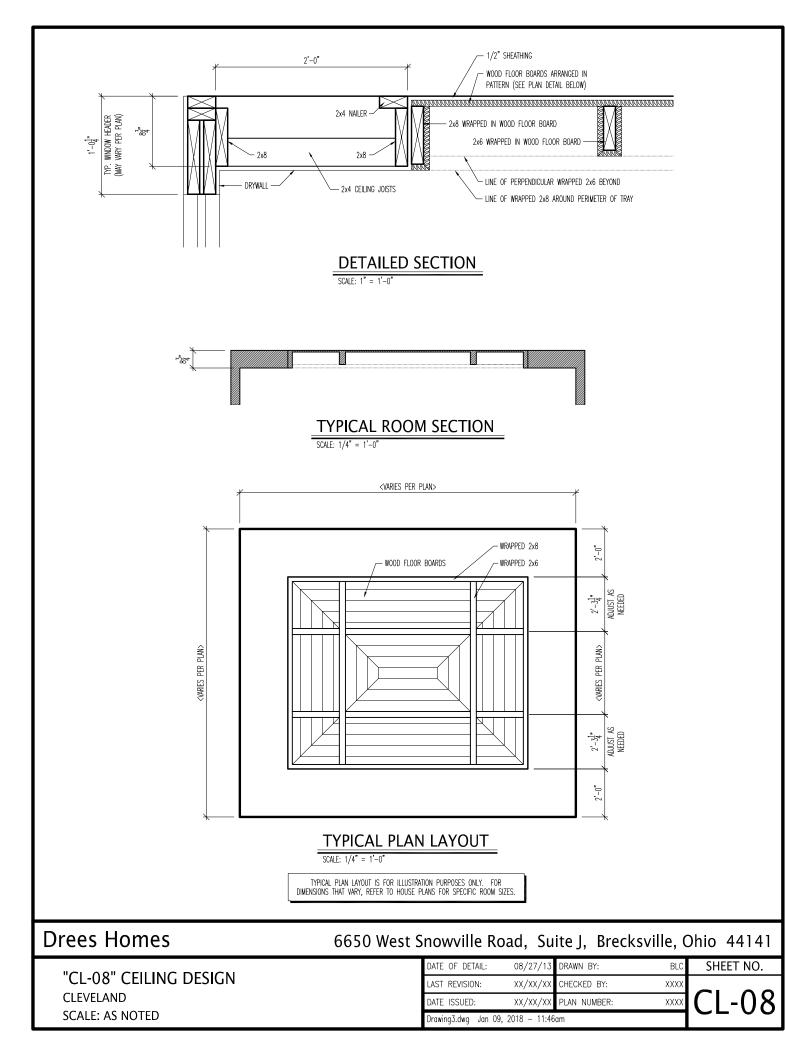

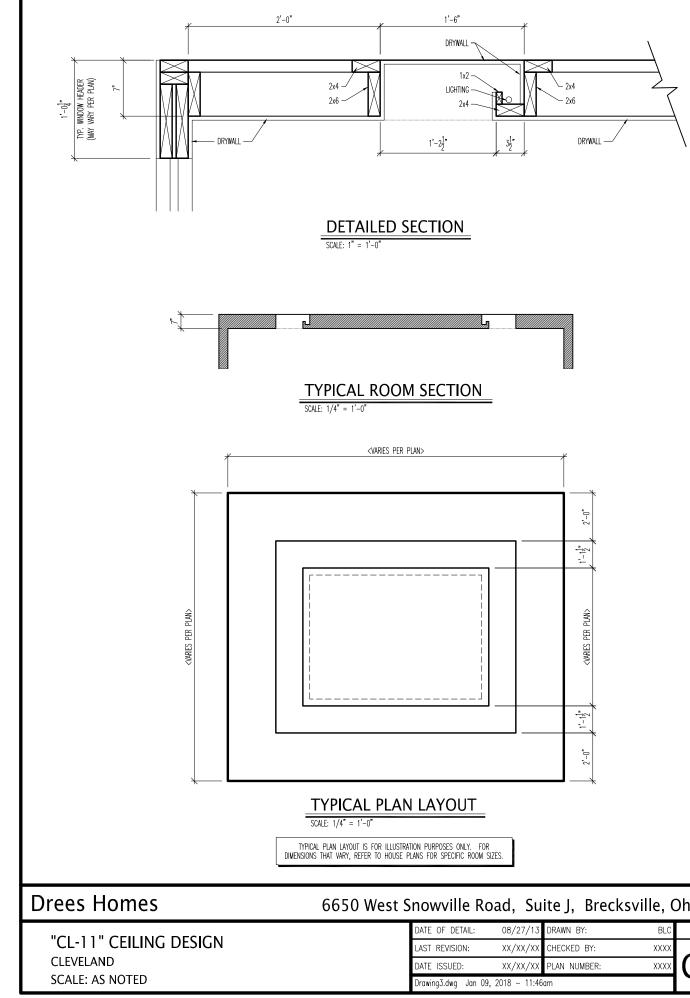
6650 West Snowville Road, Suite J, Brecksville, Ohio 44141

| DATE OF DETAIL: | 08/27/13 | DRAWN BY: | BLC | SHEET NO. |
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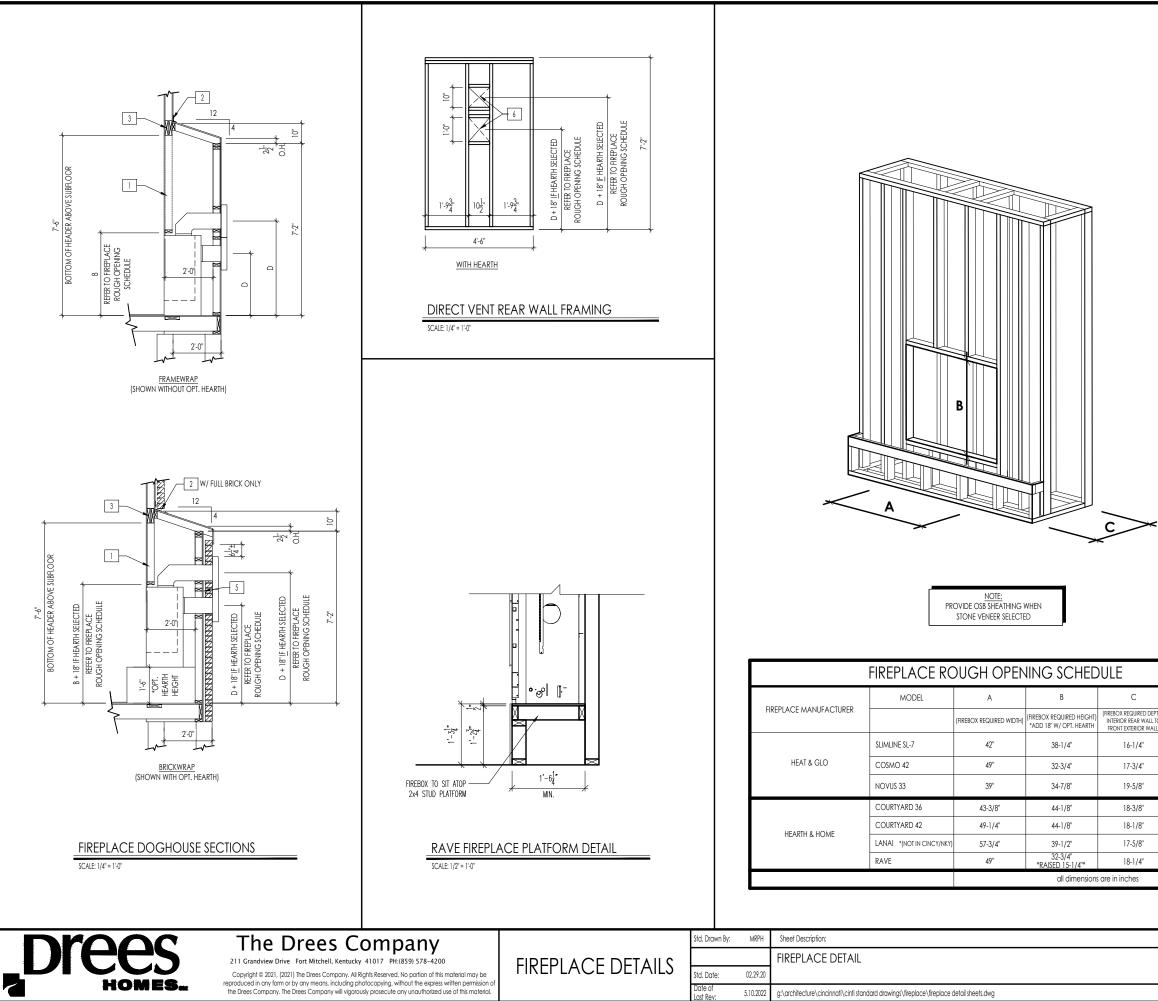


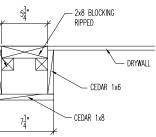


TYPICAL PLAN LAYOUT

6650 West Snowville Road, Suite J, Brecksville, Ohio 44141
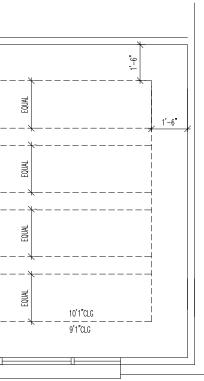
| DATE OF DETAIL: | XX/XX/XX | DRAWN BY: | XXXX | SHEET NO. |
|----------------------|--------------|--------------|------|-----------|
| LAST REVISION: | XX/XX/XX | CHECKED BY: | XXXX | |
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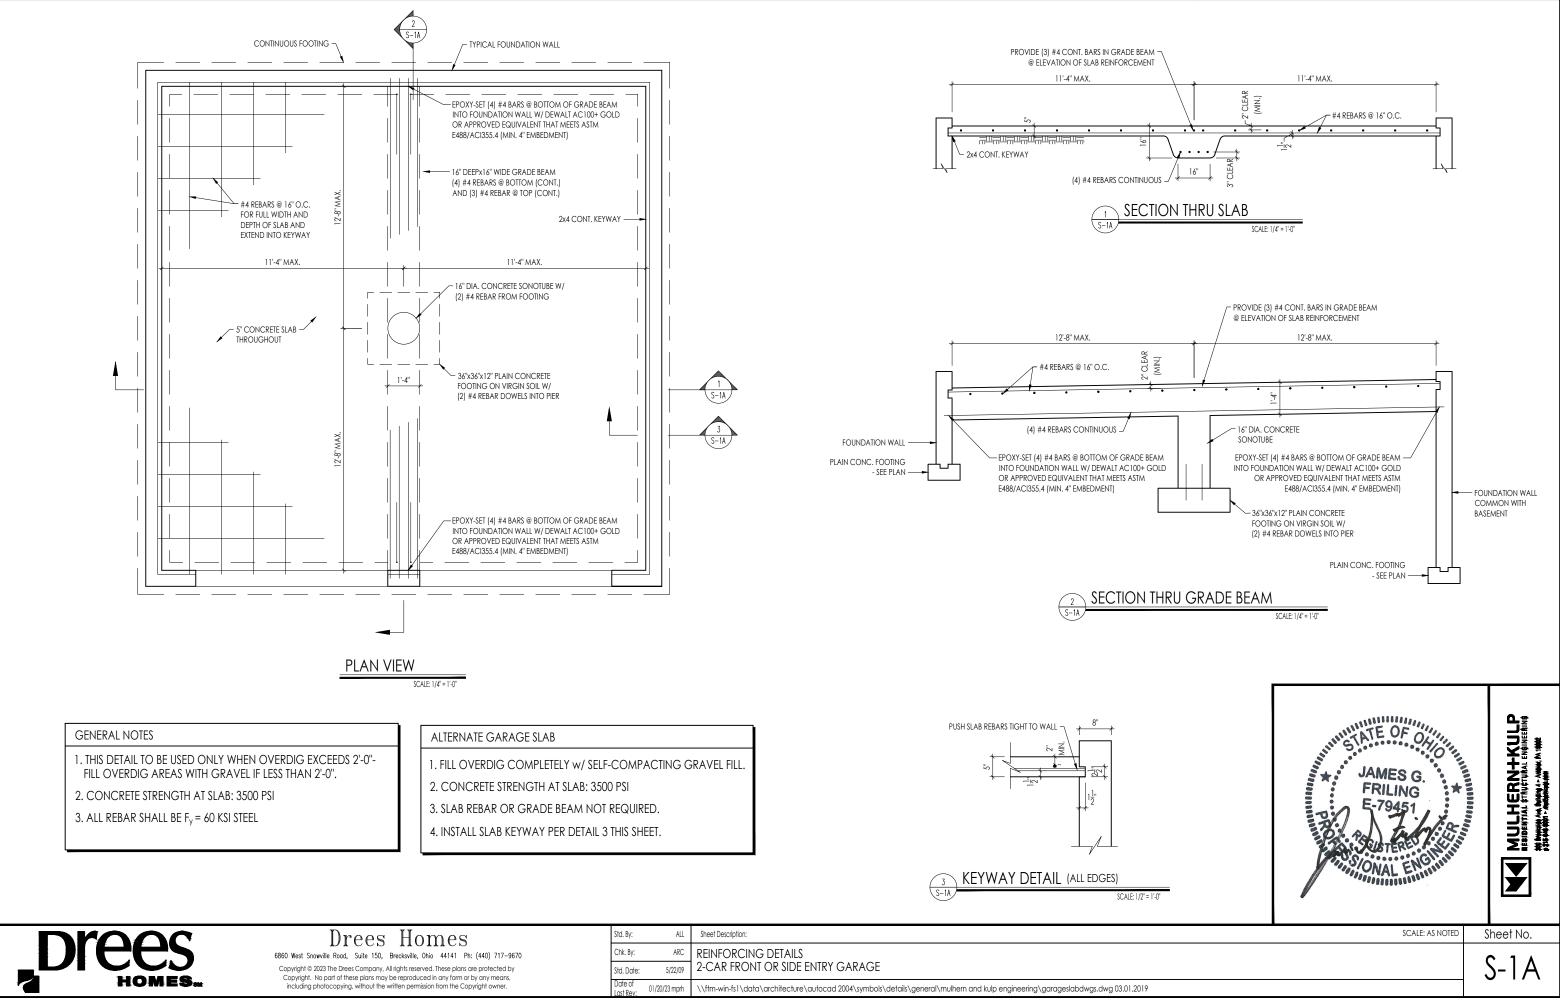


| - | | |
|---|---|--------------------------------|
| | General Notes | |
| | REFER TO SHEET 0N.1 FOR GENERAL NOTES. VERIFY FIREPLACE MODEL AND HEARTH SELECTION WITH CU | stomer's selections. |
| | | |
| | | |
| | | |
| | Key Notes | |
| | 1 FUTURE FRAMING FOR F.P. OPENING AFTER INSULATION HA | S BEEN INSTALLED IN EXT. WALLS |
| | 2 FLASHING | |
| | 3 HEADER PER PLAN | |
| | 4 | |
| | 5 1" AIRSPACE | |
| | 6 BOX OUT FOR FLUE (REFER TO SELECTIONS FOR FIREPLACE | AND OPENING HEIGHT) |
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| | | |
| D | | |
| TH - (VENT CENTERLINE HEIGHT) ADD 18" W/ OPT. HEARTH | | |
| *ADD 18" W/ OPT. HEARTH TOP 40" | | |
| SIDE 26-7/8" | | |
| TOP ONLY 47-1/16" | | |
| TOP 40" SIDE 23-1/2" | | |
| SEE MANUFACTURER'S SPECS | | |
| SEE MANUFACTURER'S SPECS | | |
| SEE MANUFACTURER'S SPECS | | |
| TOP ONLY 46-1/2" | | |
| | | |
| | | |
| | | |
| SCALE: VARIES | | Sheet No. |
| | | |
| | | F-1 |
| | | |

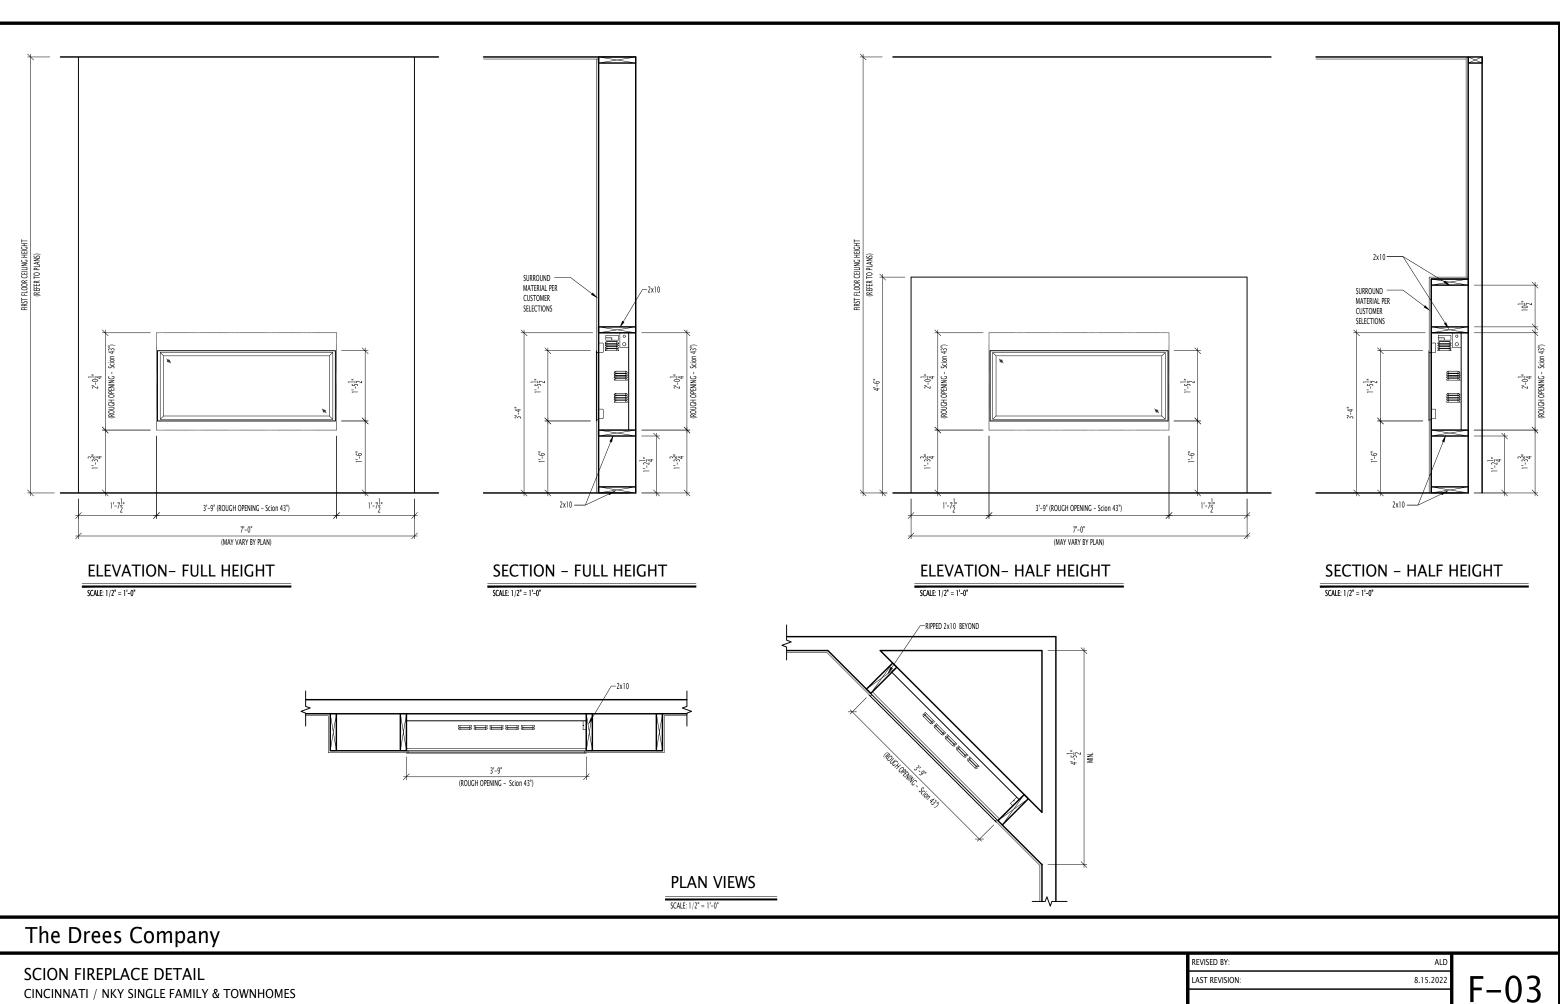


CINCINNATI / NKY SINGLE FAMILY & TOWNHOMES SCALE: NONE

| REVISED BY: | | ALD | |
|---|---|-----------------------|----|
| LAST REVISION: | | 8.15.2022 | ЕΛ |
| | | | |
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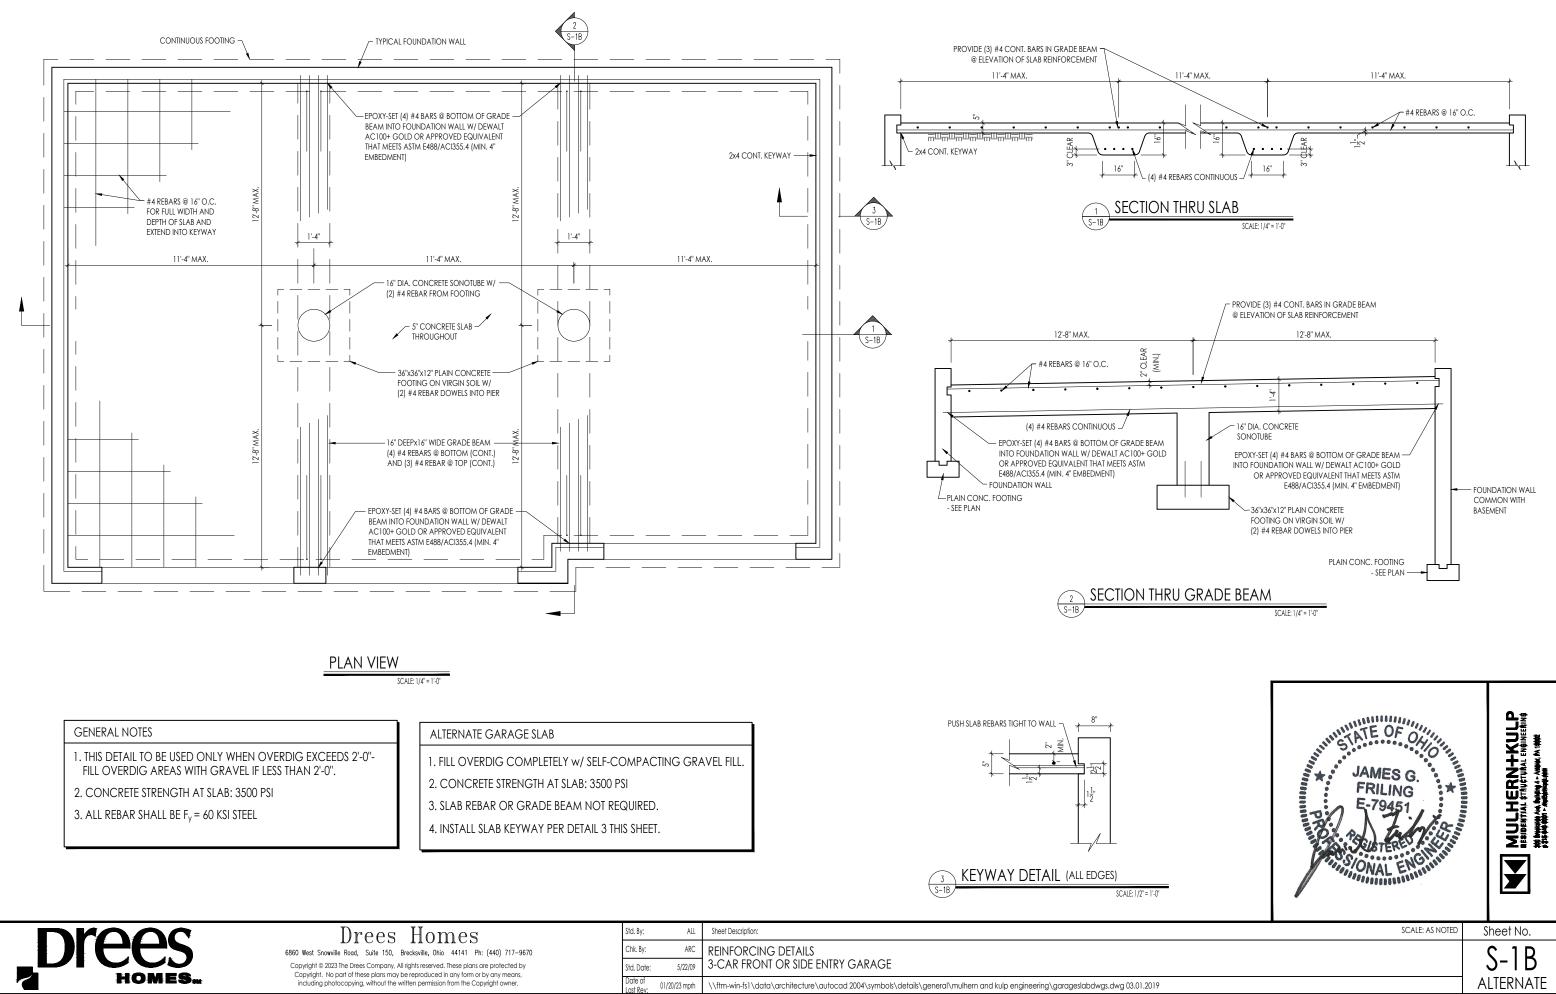






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| Chk. By: | ARC | REINFORCING DETAILS |
| Std. Date: | 5/22/09 | 2-CAR FRONT OR SIDE ENTRY GARAGE |
| Date of Last Rev: | 01/20/23 mprh | \\ftm-win-fs1\data\architecture\autocad 2004\symbols\details\general\mulhern and kulp engineering\garageslabdwgs.dwg 03.01.2019 |

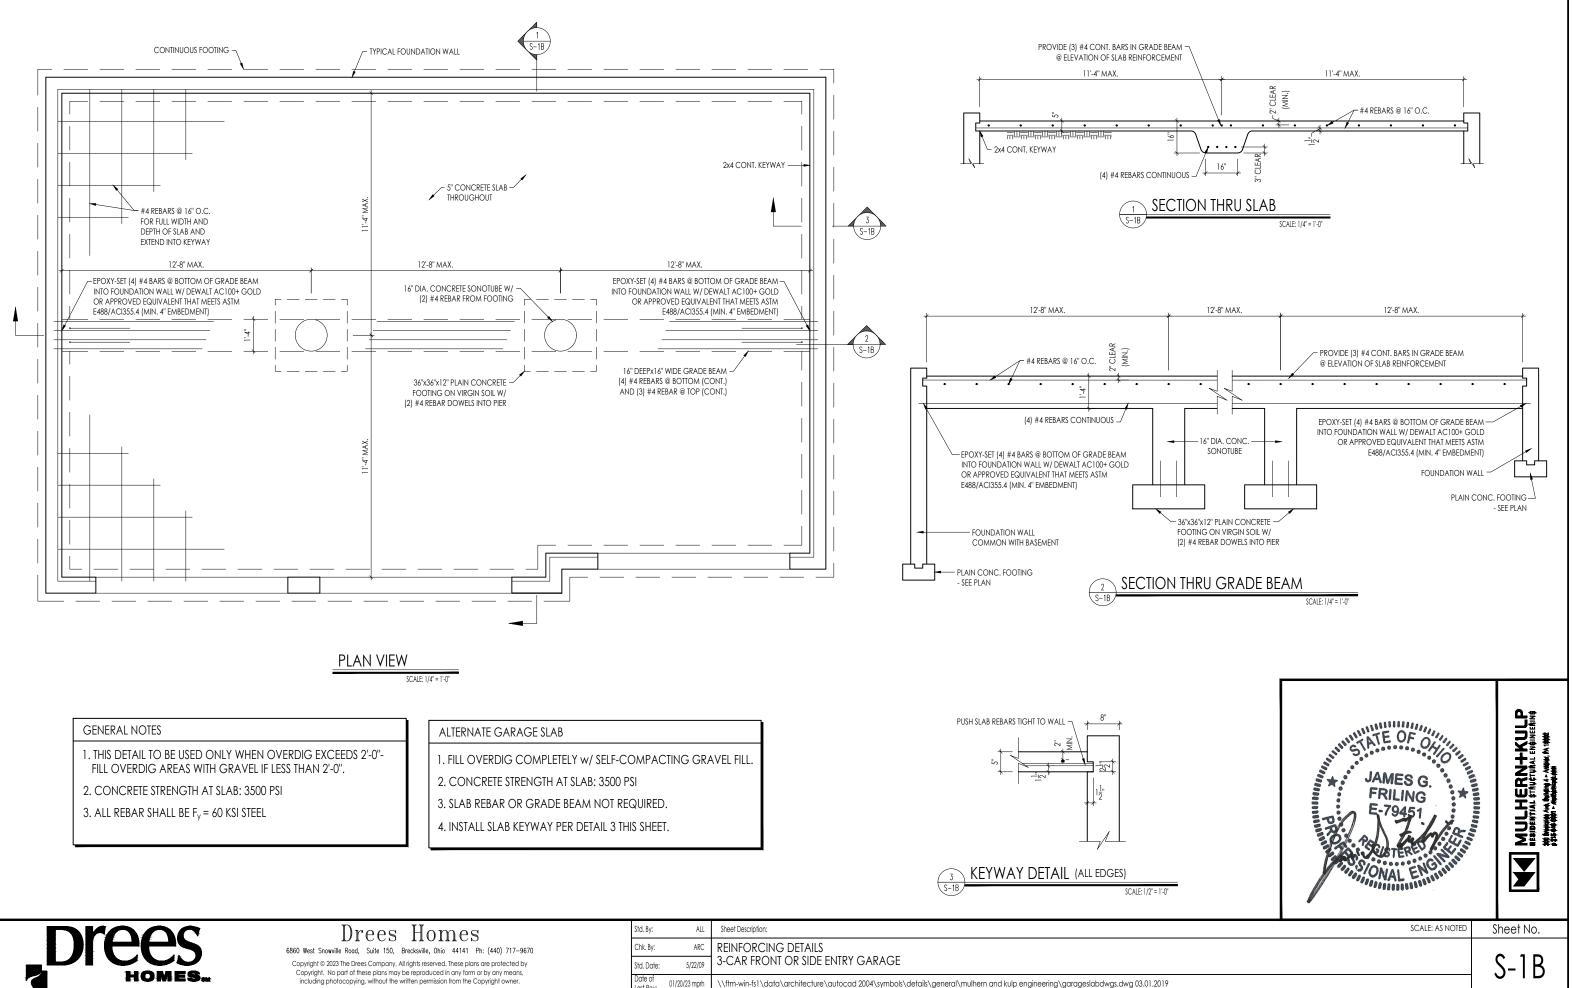

| Std. By: AL | Sheet Description: |
|-----------------------------------|---|
| Chk. By: AR | REINFORCING DETAILS |
| Std. Date: 5/22/0 | 3-CAR FRONT OR SIDE ENTRY GARAGE |
| Date of Last Rev: 01/20/23 mpr | \\ftm-win-fs1\data\architecture\autocad 2004\symbols\details\general\mulhern and kulp engineering\garageslabdwgs.dwg 03.01.2019 |
| Date of 01/20/23 mpr | 3-CAR FRONT OR SIDE ENTRY GARAGE |



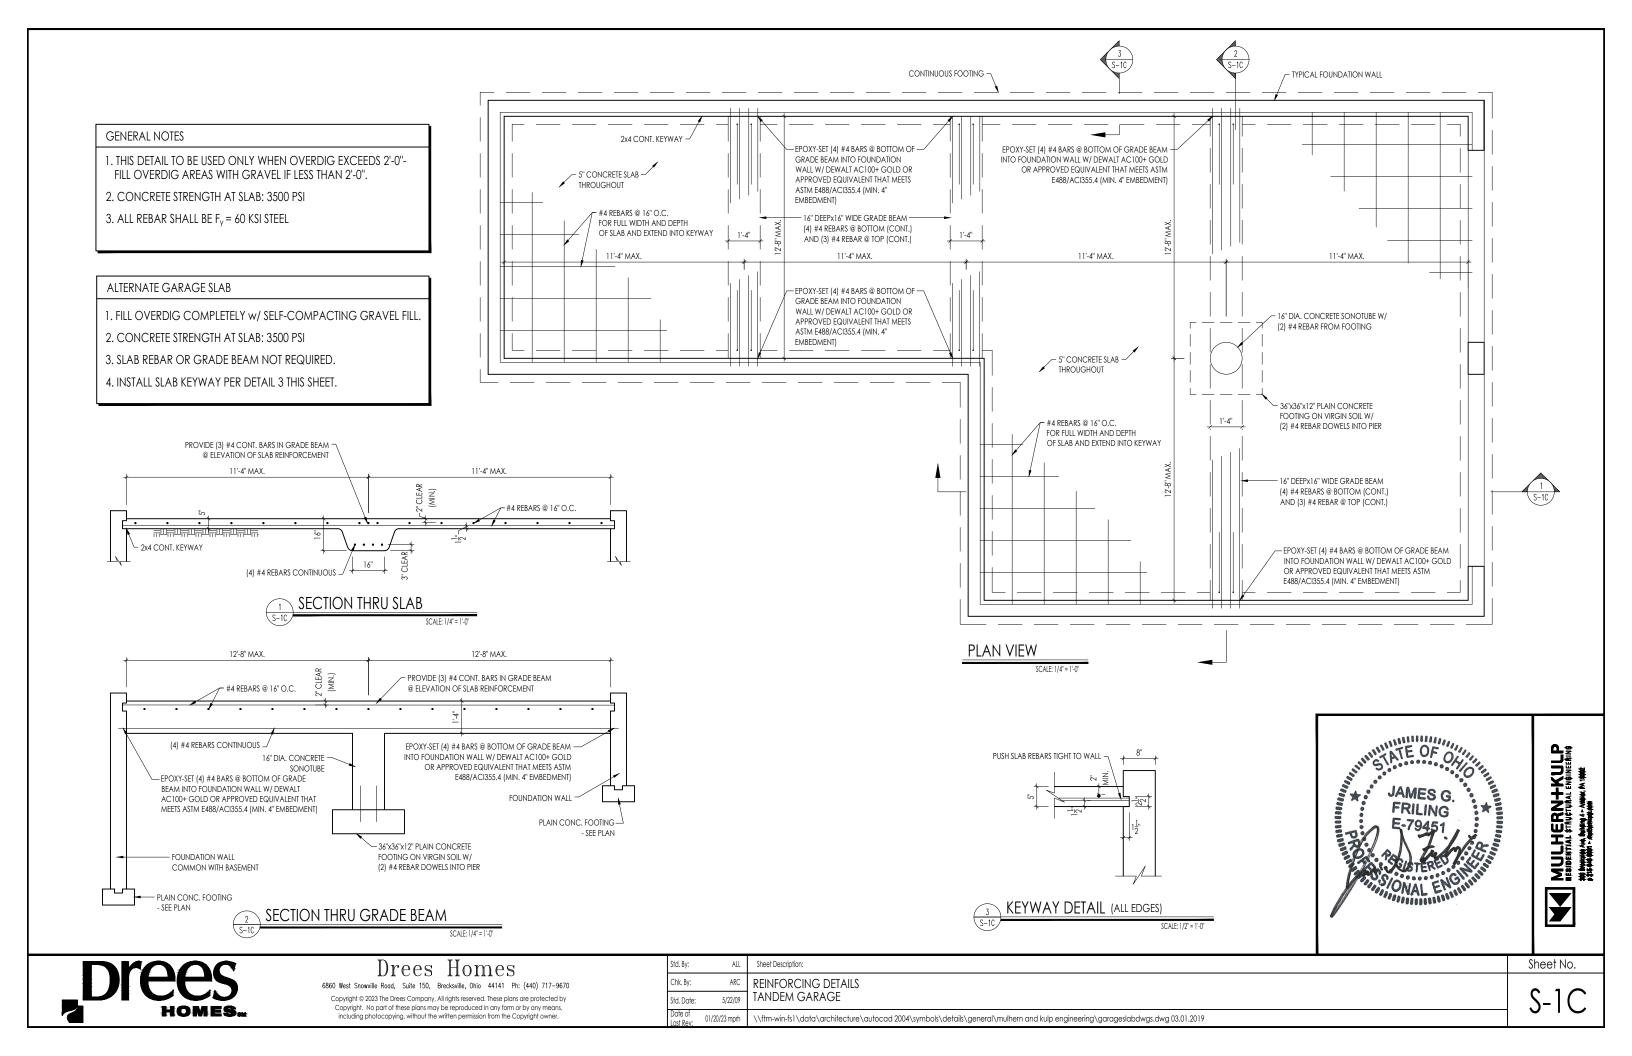

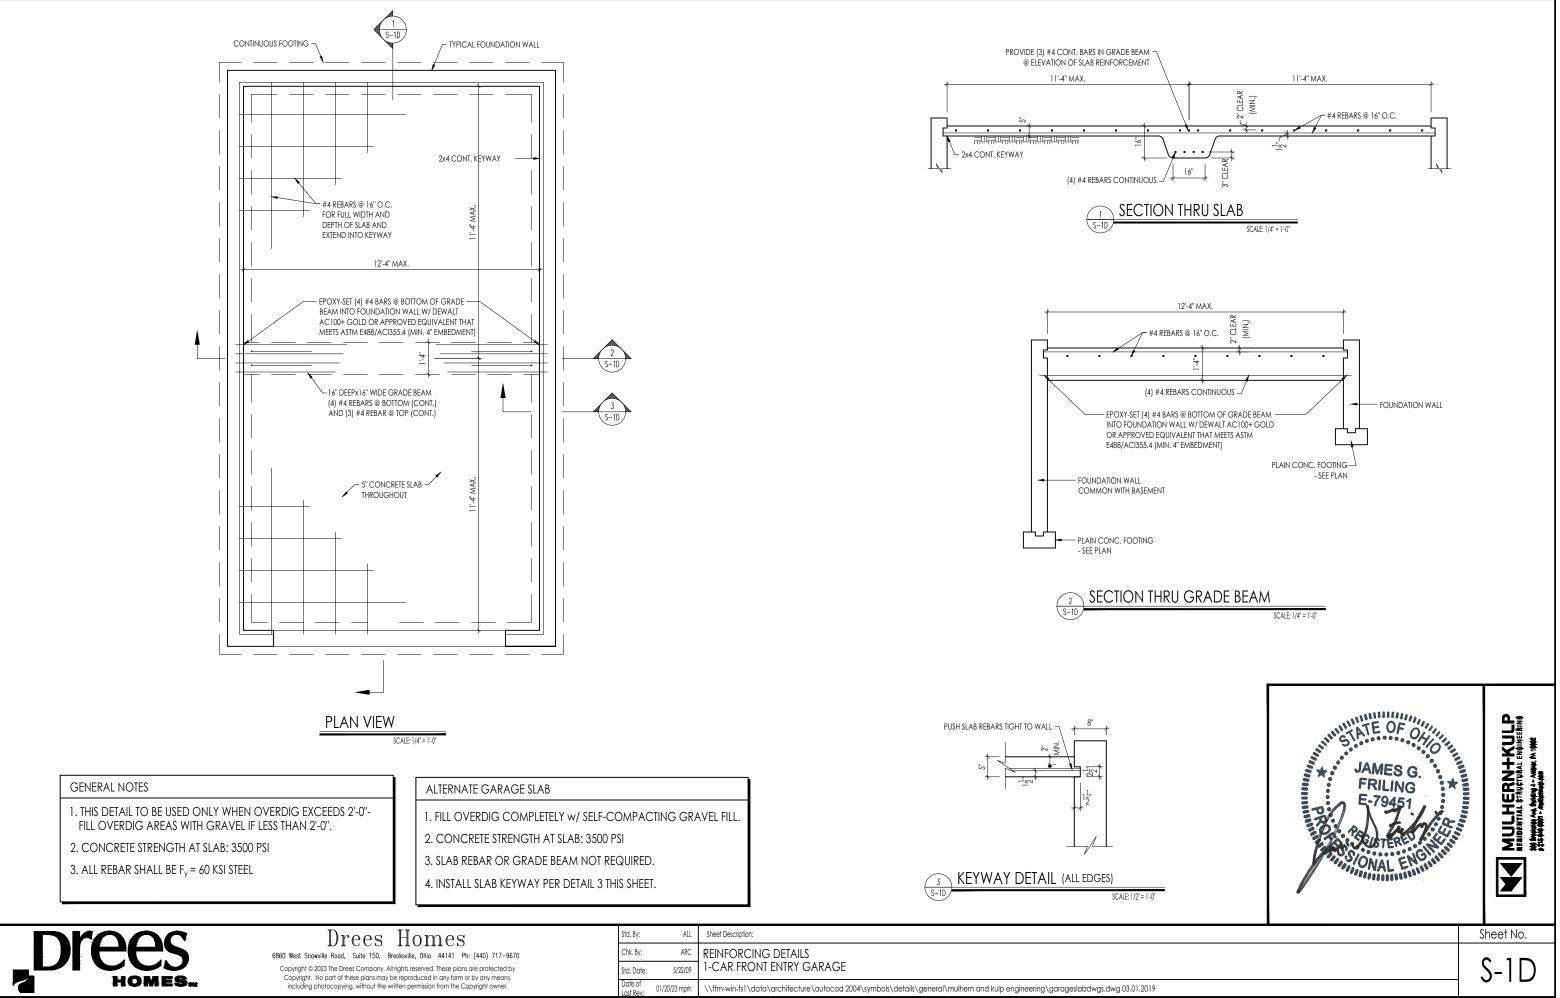

| Call of the construction of the construline of the construction of the construction of the constructio | ees General | | Pella Archi | tect Classic Clad Wood Windows | Simonto | on Vinyl Windows Brickmould 300 | Drees General | Pella Architect Cla | ssic Clad Wood Windows | Simor | nton Vinyl Windows ish Brickmould 300 |
|--|-----------------|--------------------|-----------------------|--|--------------------|---|-----------------------------------|--------------------------|-------------------------------------|--------------|--|
| | Callout | window Type | Call No. | L | | | Callout | Call No. | Rough Opening | | Rough Openir |
| State | 40 | SINGLE/DOUBLE HUNG | 2147 | 1'-9 3/4" x 3'-11 3/4" | 1840 | 1'-8" x 4'-0" | | 2547 FIXED | | 2040 | 2'-0" x 4'-0" |
| N NODE (1710) NODE (1710) <td>50</td> <td>SINGLE/DOUBLE HUNG</td> <td></td> <td></td> <td>1852</td> <td></td> <td>2050 FIXED</td> <td></td> <td></td> <td>2052</td> <td></td> | 50 | SINGLE/DOUBLE HUNG | | | 1852 | | 2050 FIXED | | | 2052 | |
| $ \begin{array}{ c c c c c c c c c c c c c c c c c c c$ | 50 70 | SINGLE/DOUBLE HUNG | | | 1860 | | 2440 FIXED | 2947 FIXED | 2'-5 3/4" x 3'-11 3/4" | 2852 | |
| Alt Statisticate intra Alt Control intra Contro intra Contro intra Contr | 30 | | | | 2030 | | 2860 FIXED | | | 2860 | |
| 4 3752 (1) 0 + 0 + 0 + 0 + 0 57 67 <td>40</td> <td></td> <td>2547</td> <td></td> <td>2040</td> <td></td> <td>3020 FIXED</td> <td>3525 FIXED</td> <td></td> <td>3020</td> <td></td> | 40 | | 2547 | | 2040 | | 3020 FIXED | 3525 FIXED | | 3020 | |
| Self 2001 Diff No. Self 2001 Diff Control 1000 Diff Diff Control 1000 Diff Diff Control 1000 Diff | -4 | SINGLE/DOUBLE HUNG | 2553 | | 2044 | 2'-0" × 4'-4" | 3030 FIXED | 3535 FIXED | 2'-11 3/4" x 2'-11 3/4" | 3030 | 3'-0" x 3'-0" |
| No. No. Provide the Pro- cent of the Provide the Pro- cent of the Provide the Pro- cent of the Provide the Pro- tent of the Provide the Pro- cent of the Pro- tent of the Pro- tent of the Pro- tent of the Pro- | 50 | SINGLE/DOUBLE HUNG | 2559 | | 2052 | | 3040 FIXED | 3547 FIXED | | 3040 | $3'-0'' \times 4'-0''$ |
| Number 2014 PDP PAPE | 70 | SINGLE/DOUBLE HUNG | | | 2068 | | | 3571 FIXED | | 3060 | |
| Sec. Sec. <th< td=""><td>0</td><td>SINGLE/DOUBLE HUNG</td><td></td><td></td><td>2452</td><td>$2'-4" \times 5'-2"$</td><td>3440 FIXED</td><td>4147 FIXED</td><td></td><td></td><td></td></th<> | 0 | SINGLE/DOUBLE HUNG | | | 2452 | $2'-4" \times 5'-2"$ | 3440 FIXED | 4147 FIXED | | | |
| 0 30.1 20.1 20.1 20.1 20.1 20.2 20 | 60 | SINGLE/DOUBLE HUNG | * 2971 | <u>2'-5 3'/4" x 5'-11 3'/4"</u> | 2460 | 2'-4" x 6'-0" | 3450 FIXED | 4159 FIXED | 3'-5 3/4" x 4'-11 3/4" | 3452 | 3'-4" x 5'-2" |
| $ \begin{array}{c c c c c c c c c c c c c c c c c c c $ | 0 | SINGLE/DOUBLE HUNG | * 29// | | * 2468 | $2'-4'' \times 6'-8''$ | 3460 FIXED | 41/1 FIXED | | 3460 | |
| 4 383 A0011 MBC 1200 | 0 | SINGLE/DOUBLE HUNG | 3347 | | 2840 | | 4040 FIXED | 4559 FIXED 4747 FIXED | | | |
| 0 380/2 ACM 1100 -1104 72-0/2 - 5-00 400/2 - 5-00 380/2 ACM 1100 410/2 - 5-00 420/2 - 5-00 400/2 - 5-00 <th< td=""><td>-4</td><td></td><td>3353</td><td></td><td>2844</td><td></td><td></td><td>4753 FIXED</td><td></td><td></td><td></td></th<> | -4 | | 3353 | | 2844 | | | 4753 FIXED | | | |
| 0 1000 0011 000 0010 0010 0011 00111 0011 0011 <t< td=""><td>0</td><td>SINGLE/DOUBLE HUNG</td><td>3359</td><td>2'-9 3/4" x 4'-11 3/4"</td><td>2852</td><td>2'-8" x 5'-2"</td><td>4050 FIXED</td><td>4757 FIXED</td><td>3'-11 3/4" x 4'-11 3/4"</td><td>4052</td><td>4'-0" x 5'-2"</td></t<> | 0 | SINGLE/DOUBLE HUNG | 3359 | 2'-9 3/4" x 4'-11 3/4" | 2852 | 2'-8" x 5'-2" | 4050 FIXED | 4757 FIXED | 3'-11 3/4" x 4'-11 3/4" | 4052 | 4'-0" x 5'-2" |
| $ \begin{array}{ c } \hline 0 & 0 & 0 & 0 & 0 & 0 & 0 & 0 & 0 & 0$ | 0 | SINGLE/DOUBLE HUNG | | | * 2860 | 2'-8" x 6'-0" | | 4771 FIXED | | | |
| S BICLEPORT HINC STATE | 0 | SINGLE/DOUBLE HUNG | * <u>55//</u> 3735 | | * 2000 3030 | | | 4/// FIXED 5347 FIXED | | 4070 4440 | |
| $ \begin{array}{c c c c c c c c c c c c c c c c c c c $ | 8 | | | | 3038 | | | 5947 FIXED | | | $5'-0" \times 4'-0"$ |
| $ \begin{array}{c c c c c c c c c c c c c c c c c c c $ | 0 | SINGLE/DOUBLE HUNG | 3747 | | 3040 | | 5044 FIXED | 5953 FIXED | 4'-11 3/4" x 4'-5 3/4" | 5044 | 5'-0" x 4'-4" |
| $ \begin{array}{ c c c c c c c c c c c c c c c c c c c$ | 4 | SINGLE/DOUBLE HUNG | 3753 | <u>3'-1 3/4" x 4'-5 3/4"</u> | 3044 | <u>3'-0" × 4'-4"</u> | 5050 FIXED | 5959 FIXED | 4'-11 3/4" x 4'-11 3/4" | 5052 | 5'-0" x 5'-2" |
| 0 SNUL/COUNT FIGURE # 272 C = 1/24 + 2 + 2/4 * 300 C = 2 + 2 + 2/4 0 SNUL/COUNT FIGURE 4 + 171 5 - 2 + 4 + 5 + 1 + 1/4 - 3462 - 4 + 6 + 2 + 2 + 2 + 2 + 2 + 2 + 2 + 2 + 2 | 0 | SINGLE/DOUBLE HUNG | | | * 3052 | | | 5971 FIXED | | 5060 | |
| 4 SNR 2/00.25 HU/S 1/4 2/5 S/4 x 4/5 S/4 3/44 3/4 x 4/2 S/4 5/4 x 4/2 S/4 0/44 0/4 S/4 0/4 S/4 <td< td=""><td>0</td><td>SINGLE/DOUBLE HUNG</td><td></td><td></td><td></td><td></td><td></td><td>71.35 FIXED</td><td></td><td></td><td></td></td<> | 0 | SINGLE/DOUBLE HUNG | | | | | | 71.35 FIXED | | | |
| 6 Sta 67/2008E H002 4 - 10/2 3 - 3 - 2 - 3 | 4 | SINGLE/DOUBLE HUNG | 4153 | | 3444 | | 6034 FIXED | 7141 FIXED | | 6034 | |
| C Statistic power halo $r + 177$ $r + 5.77$ $r + 465$ $r - 6 + 2^{-7}$ $r + + 2^{-7}$ | 0 | SINGLE/DOUBLE HUNG | * 4159 | | * 3452 | $3'-4" \times 5'-2"$ | 6040 FIXED | 7147 FIXED | | 6040 | 6'-0" x 4'-0" |
| Statistic statistics ***452 ****452 ****452 ****452 ****452 ****452 ****172 *****27 ****172 ****27 ****172 ****77 | 0 | | | | * 3460 | | | | | | |
| 0 SNR LFC03L LING # 4571 J = 3 J = 3 J = 3 J = 3 J = 2 J = | 0 | | | | | $3-4 \times 6-8$ | | | | | |
| 0 38662 (200E) L Mu2 4 452 3 -9 3/4 x 4 - 1 3/4 * 4052 -2 - 2 x 4 - 2 - 2 x 4 - 2 - 2 x 4 - 2 - 2 x 4 - 2 - 2 x 4 - 2 - 2 x 4 - 2 - 2 x 4 - 2 - 2 x 4 - 2 - 2 x 4 - 2 - 2 x 4 - 2 - 2 x 4 - 2 - 2 x 4 - 2 - 2 - 2 - 2 - 2 - 2 - 2 - 2 - 2 - | 0 | SINGLE/DOUBLE HUNG | * 4571 | | * 3860 | $3^{-0} \times 5^{-2}$ $3^{-8}^{-0} \times 6^{-0}$ | 3'-0" HALF ROUND | 3719 DOUBLE HUNG | | <u> </u> | |
| C SSGL/COLF.L HUS: * 457 X = 2,4/* x = 5,2/2 * 468 4 + 0 + x + 2 + 2 + 4 + 7 + 2 + 6 + 7 + 4 + 7 + 7 + 7 + 7 + 7 + 7 + 7 + 7 | 0 | SINGLE/DOUBLE HUNG | * 4559 | $3'-9 3'/4" \times 4'-11 3'/4"$ | * 4052 | 4'-0" x 5'-2" | 3'-8" HALF ROUND | 4121 DOUBLE HUNG | 3'-5 3/4" x 1'-9 1/4" | 3'-8" | $3'-8" \times 1'-10"$ |
| S JUBE 500 2-01 2-02 2-20 | 50 70 | SINGLE/DOUBLE HUNG | | $3'-9 3'/4" \times 5'-11 3'/4"$ | * 4060 | 4'-0" x 6'-0" | 4'-0" HALF ROUND | | | | $4'-0'' \times 2'-0''$ |
| 0 SUBR 0 SUBR 0 SUBR 0 SUBR 0 SUBR 225 FMD 22-1 3/4" 202 2-6 <t< td=""><td></td><td>SINGLE/DOUBLE HUNG</td><td>* 4577</td><td><u>3'-9 3/4" x 6'-5 3/4"</u></td><td></td><td></td><td>5'-0" HALF ROUND</td><td></td><td>$4'-11 \ 3/4'' \times 2'-6 \ 1/4''$</td><td></td><td></td></t<> | | SINGLE/DOUBLE HUNG | * 4577 | <u>3'-9 3/4" x 6'-5 3/4"</u> | | | 5'-0" HALF ROUND | | $4'-11 \ 3/4'' \times 2'-6 \ 1/4''$ | | |
| S MDR Company Company <thcompany< th=""> <thcompany< th=""> <thcom< td=""><td>-0 SLIDER</td><td></td><td></td><td></td><td>3040</td><td></td><td></td><td></td><td></td><td><u> </u></td><td></td></thcom<></thcompany<></thcompany<> | -0 SLIDER | | | | 3040 | | | | | <u> </u> | |
| 4 SLER 4 <td>20 SLIDER</td> <td></td> <td></td> <td></td> <td>4020</td> <td>4'-0" x 2'-0"</td> <td>2'-8" QUARTER ROUND</td> <td></td> <td></td> <td></td> <td></td> | 20 SLIDER | | | | 4020 | 4'-0" x 2'-0" | 2'-8" QUARTER ROUND | | | | |
| S SUBER Pairs Sider Not Available * 4400 4'-0' Sider 9402 3'-2' 4'-0' S SUBER | SO SLIDER | | | | 4030 | | 3'-0" QUARTER ROUND | | | <u> </u> | |
| S UDR S UDR 4 20ER Pela Sider Not Available Use Cosement **150 **503 1-1** S ⁻ C ⁰ 3000 ***505 3000 ****00* 3000 *****00* 30000 *****00* 3000****0 | | | | | 4034 | | 2850 ELONGATED QUARTER ROUND | | | 2850 | |
| S SLDER Pello Silder Nat Available 3030 5°-0" x 3°-0" 5030 6°-0" x 3°-0" 5030 5°-0" x 3°-0" 5030 6°-0" x 3°-0" 5000 6°-0" x 3°-0" 5000 5000 5000 5000 5000 5000 5000 5000 5000 5000 5000 5000 | | | | | * 4150 | $4^{-0} \times 4^{-0}$ | | | | | |
| No. Construction No. Construction< | 0 SLIDER | | Pella S | Slider Not Available | 5030 | $5'-0'' \times 3'-0''$ | 5050 ELONGATED ELLIPTICAL | | | | 5'-0" x 5'-0" |
| A JUNCh Sold Ch Sold Ch <t< td=""><td>4 SLIDER</td><td></td><td></td><td></td><td>5034</td><td>$5'-0" \times 3'-4"$</td><td></td><td></td><td></td><td></td><td>$6'-0" \times 5'-0"$</td></t<> | 4 SLIDER | | | | 5034 | $5'-0" \times 3'-4"$ | | | | | $6'-0" \times 5'-0"$ |
| 0 SUDER 6030 6'-0" x 3'-0" 2440 FXED EVE 2'-4 1/4" x 4'-0" 2440 FXED EVE 2'-4 1/4" x 4'-0" 0 SUDER * 6040 6'-0" x 3'-0" * 6040 6'-0" x 4'-0" 2440 FXED EVE 2'-4 1/4" x 4'-0" 2440 FXED EVE 2'-4 1/4" x 4'-0" 0 SUDER * 6060 6'-0" x 3'-0" * 6060 6'-0" x 5'-0" 9050 9'-0" x 5'-0" 0 SUDER * 6050 6'-0" x 5'-0" 9050 9'-0" x 5'-0" 0 CASEMEN 1747-IR 2'-10 3/4" x 2'-11 3/4" | O SLIDER | | | | * 5040 | $5 - 0 \times 4 - 0$ $5' - 0'' \times 5' - 0''$ | 3045 PARTIAL ELONGATED ELLIPTICAL | | | 4046 | $3 - 0 \times 4 - 5$ |
| 4 SLDER 6034 6-0° x 3'-4° 0 SLDER * 6050 6'-0° x 4'-0° 0 SLDER * 6050 6'-0° x 5'-0° 0 SLDER * 7050 7'-0° x 5'-0° 0 CASEMENT 1747-LR 2'-10 3/4" x 2'-11 3/4" * 0 CASEMENT 2255-LR 4'-2 3/4" x 2'-11 3/4" * 0 CASEMENT 2255-LR 4'-2 3/4" x 2'-11 3/4" * 0 CASEMENT 2254'-LR 4'-2 3/4" x 3'-13 3/4" * 0 CASEMENT 224'-LR 4'-2 3/4" x 3'-13 3/4" * 0 CASEMENT 224'-LR 4'-10 3/4" x 2'-11 3/4" * 0 CASEMENT 294'-LR 4'-10 3/4" x 2'-11 3/4" * 0 CASEMENT 294'-LR 4'-10 3/4" x 2'-11 3/4" * 0 CASEMENT 294'-LR 4'-10 3/4" x 2'-11 3/4" * 0 CASEMENT 294'-LR | | | | | 6030 | $6'-0" \times 3'-0"$ | 2440 FIXED ARCH | 2440 FIXED EYE | 2'-4 1/4" x 4'-0" | | $2'-4 \frac{1}{4''} \times 4'-0''$ |
| 0 SLOCR * 6040 6-0" x 4-0" 0 SLOER * 6050 6-0" x 5-0" 7050 7'-0" x 5'-0" 7050 7'-0" x 5'-0" 9050 9'-0" x 5'-0" 9050 9'-0" x 5'-0" 0 CASEMENT 11747-LR 2'-10 3/4" x 2'-11 3/4" 0 CASEMENT 2255-LR 4'-2 3/4" x 2'-11 3/4" 0 CASEMENT 2255-LR 4'-2 3/4" x 2'-11 3/4" 0 CASEMENT 2251-LR 4'-2 3/4" x 2'-11 3/4" 0 CASEMENT 2251-LR 4'-2 3/4" x 2'-11 3/4" 0 CASEMENT 2247-LR 4'-2 3/4" x 2'-11 3/4" 0 CASEMENT 2247-LR 4'-10 3/4" x 2'-11 3/4" 0 CASEMENT 2247-LR 4'-10 3/4" x 3'-11 3/4" 0 CASEMENT 2247-LR 4'-10 3/4" x 3'-13 3/4" 0 CASEMENT 2247-LR 4'-10 3/4" x 3'-13 3/4" 0 CASEMENT 235-LR 5'-10 3/4" x 3'-11 3/4" 0 CASEMENT 2347-LR 5'-10 3/4" x 3'-11 3/4" 0 CASEMENT 235-LR 5'-10 3/4" x 3'-1 3/4" 0 CASEMENT 355-LR 5'-10 3/4" x 3'-1 3/4" | 4 SLIDER | | | | 6034 | 6'-0" x 3'-4" | | • | | | • • • • • |
| O SLIDER 7500 7'-0" x 5'-0" 9000 9000 9'-0" x 5'-0" 0 CASEMENT 1747-IR 2'-10.3/4" x 2'-11.3/4" 0 CASEMENT 1747-IR 2'-10.3/4" x 2'-11.3/4" 0 CASEMENT 2525-LR 4'-2.3/4" x 2'-11.3/4" 0 CASEMENT 2555-LR 4'-2.3/4" x 2'-11.3/4" 0 CASEMENT 2541-LR 4'-2.3/4" x 2'-11.3/4" 0 CASEMENT 2547-LR 4'-2.3/4" x 2'-11.3/4" 0 CASEMENT 2547-LR 4'-2.3/4" x 2'-11.3/4" 0 CASEMENT 2597-LR 4'-2.3/4" x 2'-11.3/4" 0 CASEMENT 2937-LR 4'-10.3/4" x 2'-11.3/4" 0 CASEMENT 2937-LR 4'-10.3/4" x 2'-11.3/4" 0 CASEMENT 2937-LR 4'-10.3/4" x 2'-11.3/4" 0 CASEMENT 2947-LR 4'-10.3/4" x 2'-11.3/4" 0 CASEMENT 2947-LR 4'-10.3/4" x 3'-13.4/4" 0 CASEMENT 3559 | 0 SLIDER | | | | * 6040 | 6'-0" x 4'-0" | | | | | |
| O SLIDER 9050 9'-0" x 5'-0" 0 CASEMENT 1735-LR 2'-10 3/4" x 2'-11 3/4" | <u>O SLIDER</u> | | | | | | | | | | |
| 0 CASEMENT 1747-LR 2'-10 3/4" x 2'-1 3/4" 0 CASEMENT 2525-LR 4'-2 3/4" x 2'-1 3/4" 0 CASEMENT 2535-LR 4'-2 3/4" x 2'-1 3/4" 4 CASEMENT 2547-LR 4'-2 3/4" x 3'-5 3/4" 0 CASEMENT 2547-LR 4'-2 3/4" x 3'-5 3/4" 0 CASEMENT 2547-LR 4'-2 3/4" x 4'-11 3/4" 0 CASEMENT 2559-LR 4'-2 3/4" x 4'-11 3/4" 0 CASEMENT 2935-LR 4'-10 3/4" x 4'-11 3/4" 0 CASEMENT 2941-LR 4'-10 3/4" x 3'-5 3/4" 0 CASEMENT 2941-LR 4'-10 3/4" x 3'-11 3/4" 0 CASEMENT 2947-LR 4'-10 3/4" x 3'-5 3/4" 0 CASEMENT 2947-LR 4'-10 3/4" x 3'-11 3/4" 0 CASEMENT 2947-LR 4'-10 3/4" x 3'-5 3/4" 0 CASEMENT 3535-LR 5'-10 3/4" x 3'-11 3/4" 0 CASEMENT 3547-LR 5'-10 3/4" x 3'-11 3/4" | O SLIDER | | | | 9050 | 9'-0" x 5'-0" | | | | | |
| 0 CASEMENT 2525-LR 4'-2'3/4" x 2'-1'3/4" 0 CASEMENT 253-LR 4'-2'3/4" x 2'-1'3/4" 4 CASEMENT 2541-LR 4'-2'3/4" x 3'-1'1' 0 CASEMENT 2547-LR 4'-2'3/4" x 3'-1'1' 0 CASEMENT 2547-LR 4'-2'3/4" x 4'-1'1' 0 CASEMENT 2935-LR 4'-2'1'' 0 CASEMENT 2935-LR 4'-2''' 0 CASEMENT 2935-LR 4'-1''' 0 CASEMENT 2935-LR 4''-1''' 0 CASEMENT 2947-LR 4'-10''''''''''''''''''''''''''''''''''' | | | | <u>2'-10 3/4" x 2'-11 3/4"</u> | | | | | | | |
| 0 CASEMENT 2535-LR 4'-2 3/4" x 2'-11 3/4" 4 CASEMENT 2541-LR 4'-2 3/4" x 3'-5 3/4" 0 CASEMENT 2547-LR 4'-2 3/4" x 4'-11 3/4" 0 CASEMENT 259-LR 4'-2 3/4" x 4'-11 3/4" 0 CASEMENT 2935-LR 4'-2 3/4" x 4'-11 3/4" 0 CASEMENT 2935-LR 4'-10 3/4" x 2'-11 3/4" 0 CASEMENT 2941-LR 4'-10 3/4" x 3'-5 3/4" 0 CASEMENT 2941-LR 4'-10 3/4" x 3'-1 3/4" 0 CASEMENT 2947-LR 4'-10 3/4" x 4'-11 3/4" 0 CASEMENT 2947-LR 4'-10 3/4" x 4'-11 3/4" 0 CASEMENT 2947-LR 4'-10 3/4" x 4'-11 3/4" 0 CASEMENT 2959-LR 5'-10 3/4" x 4'-11 3/4" 0 CASEMENT 3535-LR 5'-10 3/4" x 3'-11 3/4" 0 CASEMENT 3547-LR 5'-10 3/4" x 3'-11 3/4" 0 CASEMENT 3559-LR 5'-10 3/4" x 4'-11 3/4" 0 CASEMENT 3559-LR 5'-10 3/4" x 4'-11 3/4" | O CASEMENT | | | $2'-10 3/4'' \times 3'-11 3/4''$ | | | | | | | |
| 4 CASEMENT 2541-LR 4'-2, 3'/4" x 3'-5, 3'/4" O CASEMENT 2547-LR 4'-2, 3'/4" x 3'-11, 3'/4" O CASEMENT 2559-LR 4'-2, 3'/4" x 4''-11, 3'/4" D CASEMENT 2935-LR 4'-10, 3'/4" x 2'-11, 3'/4" O CASEMENT 2935-LR 4'-10, 3'/4" x 2'-11, 3'/4" O CASEMENT 2935-LR 4'-10, 3'/4" x 3'-5, 3'/4" O CASEMENT 2947-LR 4'-10, 3'/4" x 3'-5, 3'/4" O CASEMENT 2947-LR 4'-10, 3'/4" x 4'-11, 3'/4" O CASEMENT 2959-LR 4'-10, 3'/4" x 4'-11, 3'/4" O CASEMENT 2959-LR 4'-10, 3'/4" x 4'-11, 3'/4" O CASEMENT 2959-LR 4'-10, 3'/4" x 4'-11, 3'/4" O CASEMENT 353-LR 5'-10, 3'/4" x 4'-11, 3'/4" O CASEMENT 3541-LR 5'-10, 3'/4" x 4'-11, 3'/4" O CASEMENT 3547-LR 5'-10, 3'/4" x 4'-11, 3'/4" O CASEMENT 3559-LR 5'-10, 3'/4" x 4'-11, 3'/4" O CASEMENT 3559-LR 5'-10, 3'/4" x 4'-11, 3'/4" O CASEMENT 3559-LR 5'-10, 3'/4" x 4'-11, 3'/4" | CASEMENT | | 2535-LR | 4 - 2 - 3/4 + 2 - 1 - 3/4 4' - 2 - 3/4'' + 2' - 11 - 3/4'' | | | | | | | |
| D CASEMENT 2547-LR 4'-2 3/4" x 3'-11 3/4" D CASEMENT 2559-LR 4'-10 3/4" x 3'-11 3/4" D CASEMENT 2935-LR 4'-10 3/4" x 3'-5 3/4" 4 CASEMENT 2941-LR 4'-10 3/4" x 3'-5 3/4" D CASEMENT 2947-LR 4'-10 3/4" x 3'-11 3/4" D CASEMENT 2947-LR 4'-10 3/4" x 3'-11 3/4" D CASEMENT 2947-LR 4'-10 3/4" x 3'-11 3/4" D CASEMENT 2947-LR 4'-10 3/4" x 2'-11 3/4" D CASEMENT 2959-LR 4'-10 3/4" x 2'-11 3/4" D CASEMENT 2959-LR 5'-10 3/4" x 3'-5 3/4" D CASEMENT 3541-LR 5'-10 3/4" x 3'-5 3/4" D CASEMENT 3547-LR 5'-10 3/4" x 3'-11 3/4" D CASEMENT 3559-LR 5'-10 3/4" x 4'-11 3/4" D CASEMENT 3559-LR 5'-10 3/4" x 4'-11 3/4" | 4 CASEMENT | | 2541-LR | $\frac{7}{4'-2}\frac{2}{3/4''}\frac{7}{x}\frac{2}{3'-5}\frac{1}{3/4''}$ | | | | | | | |
| CASEMENT 2939-LR 4 -10 3/4 x 4 -11 3/4 1 D CASEMENT 3535-LR 5'-10 3/4" x 2'-11 3/4" 1 4 CASEMENT 3541-LR 5'-10 3/4" x 3'-5 3/4" 1 D CASEMENT 3547-LR 5'-10 3/4" x 3'-1 3/4" 1 D CASEMENT 3547-LR 5'-10 3/4" x 3'-1 3/4" 1 D CASEMENT 3559-LR 5'-10 3/4" x 4'-11 3/4" 1 D CASEMENT 3559-LR 5'-10 3/4" x 4'-11 3/4" 1 M M M M M M M M M M M M M M M M M M M |) CASEMENT | | 2547-LR | $1 A' = 2 \overline{3} / A'' \sqrt{3} \overline{3} = 11 \overline{3} / A''$ | | | | | | | |
| CASEMENT 2939-LR 4 -10 3/4 x 4 -11 3/4 1 D CASEMENT 3535-LR 5'-10 3/4" x 2'-11 3/4" 1 4 CASEMENT 3541-LR 5'-10 3/4" x 3'-5 3/4" 1 D CASEMENT 3547-LR 5'-10 3/4" x 3'-1 3/4" 1 D CASEMENT 3547-LR 5'-10 3/4" x 3'-1 3/4" 1 D CASEMENT 3559-LR 5'-10 3/4" x 4'-11 3/4" 1 D CASEMENT 3559-LR 5'-10 3/4" x 4'-11 3/4" 1 M M M M M M M M M M M M M M M M M M M | J CASEMENT | | 2559-LR | $4'-2 3/4'' \times 4'-11 3/4''$ | | | | | | | |
| CASEMENT 2939-LR 4 -10 3/4 x 4 -11 3/4 1 D CASEMENT 3535-LR 5'-10 3/4" x 2'-11 3/4" 1 4 CASEMENT 3541-LR 5'-10 3/4" x 3'-5 3/4" 1 D CASEMENT 3547-LR 5'-10 3/4" x 3'-5 3/4" 1 D CASEMENT 3547-LR 5'-10 3/4" x 3'-11 3/4" 1 D CASEMENT 3559-LR 5'-10 3/4" x 4'-11 3/4" 1 D CASEMENT 3559-LR 5'-10 3/4" x 4'-11 3/4" 1 D CASEMENT 3559-LR 5'-10 3/4" x 4'-11 3/4" 1 | 4 CASEMENT | | 2930-LK 2941-LR | $\begin{array}{c ccccccccccccccccccccccccccccccccccc$ | | | | | | | |
| 2939-LR 4-10 3/4 x 4-11 3/4 0 CASEMENT 3535-LR 5'-10 3/4" x 2'-11 3/4" 4 CASEMENT 3541-LR 5'-10 3/4" x 3'-5 3/4" 0 CASEMENT 3547-LR 5'-10 3/4" x 3'-5 3/4" 0 CASEMENT 3547-LR 5'-10 3/4" x 3'-11 3/4" 0 CASEMENT 3559-LR 5'-10 3/4" x 4'-11 3/4" | 0 CASEMENT | | 2947-LR | $4'-10 \ 3/4'' \times 3'-11 \ 3/4''$ | | | | | | | |
| 0 CASEMENT 3535-LR 5'-10 3/4" x 2'-11 3/4" 4 CASEMENT 3541-LR 5'-10 3/4" x 3'-5 3/4" 0 CASEMENT 3547-LR 5'-10 3/4" x 3'-11 3/4" 0 CASEMENT 3559-LR 5'-10 3/4" x 4'-11 3/4" 0 CASEMENT 3559-LR 5'-10 3/4" x 4'-11 3/4" | 0 CASEMENT | | 2959-LR | 4 - 10 - 3/4 + x - 4 - 11 - 3/4 | | | | | | | |
| O CASEMENT 3547-LR 5'-10 3/4" x x'-11 3/4" 0 CASEMENT 3559-LR 5'-10 3/4" x 4'-11 3/4" | | | 3535-LR | $\frac{5'-10}{5'}\frac{3}{4''} \times \frac{2'-11}{5'}\frac{3}{4''}$ | | | | | | | |
| 0 CASEMENT 3559-LR 5'-10 3/4" x 4'-11 3/4" | H CASEMENT | | | $\begin{array}{c ccccccccccccccccccccccccccccccccccc$ | 1 | | | | | | |
| The Drees Company Sheet Description: Sheet | CASEMENT | | | <u>5'-10 3/4" x 4'-11 3/4"</u> | | | | | | | |
| Sheet Description: | | | | | | | | | | | |
| | N C | | The Drees | Company | Sheet Description: | · · · | | | | | Shee |

MOULDED MILLWORK SCHEDULE

| Drees General Callout | Nuwood | Fypon |
|--|----------------------|-----------------------------|
| ARCHED HEADER D1 | H8xxEFR | N/A |
| ARCHED HEADER D1K | H8xxEFKR | N/A |
| ARCHED HEADER D2 | H8xxEFTR | N/A |
| ARCHED HEADER D2K | H8xxEFTKR | N/A |
| ARCHED HEADER D3 | AH10xx | WCHSEGxxX10 |
| ARCHED HEADER D3K | N/A | WCHSEGxxX10K |
| ARCHED HEADER D4 | AR5xx | ARxxX6M |
| ARCHED HEADER D4K ARCHED HEADER D5 | AR5xxK AR10xxEC | ARxxX6MK ARxxX6METAR6C |
| ARCHED HEADER DS | ARTOXXEC | ARXXXOMETAROC |
| ARCHED HEADER D6 | AR10xxC | ARXX10MC |
| ARCHED HEADER D6K | AR10xxCK | ARxxX10MCK |
| ARCHED HEADER D7K | H7xxEF-4K | N/A |
| ARCHED HEADER D8 | AR14xxC | ARxxX14MC |
| ARCHED HEADER D8K | AR14xxCK | ARxxX14MCK |
| ARCHED HEADER D9 | H9xxE | WCHARSxx13 |
| ROSSHEAD A1 | H9xx | WCHxxX9N |
| CROSSHEAD A1K | H9xxK H14xxBT | WCHxxX9NK WCHxxX14BT |
| ROSSHEAD BIK | H14xxB1 H14xxBTK | WCHXXX14B1 WCHXXX14BTK |
| ROSSHEAD B2 | H14XXBIK H12XX | WCHXXX14BIK WCHXXX12 |
| CROSSHEAD B2K | H12xxK | WCHXX12 WCHxX12K |
| CROSSHEAD C1 | H18xxBT | WCHxxX14BT |
| CROSSHEAD C1K | H18xxBTK | WCHxxX14BTK |
| CROSSHEAD C2 | H18xxBT-PA | LDCHxxX18 |
| CROSSHEAD C2K | H18xxBTK-PA | LDCHxxX18K |
| ROSSHEAD Z-E1-HDR | Z-E1-HDR | Z-E1-HDR |
| CROSSHEAD Z-E2-HDR CROSSHEAD Z-E3-HDR | Z-E2-HDR Z-E3-HDR | Z-E2-HDR Z-E3-HDR |
| CROSSHEAD Z-E3-ARCHHDR | Z-E3-ARCHHDR | Z-E3-ARCHHDR |
| CROSSHEAD Z-E3-AKCHINDK | Z-E3-CLHDR | Z-E3-CLHDR |
| CROSSHEAD Z-ES-HDR | Z-ES-HDR | Z-E5-HDR |
| VINDOW HEADER A1 | H6xx | WCHxxX6 |
| VINDOW HEADER A1K | H6xxK | WCHxxX6K |
| VINDOW HEADER B1 | H9xx-2 | WCHxxX9N |
| VINDOW HEADER B1K | H9xx-2K | WCHxxX9NK |
| VINDOW HEADER B2 VINDOW HEADER B2K | H9xxBT H9xxBTK | WCHxxX10NBT WCHxxX10NBTK |
| VINDOW HEADER 62K | Н9хх | CCAxxX10 |
| VINDOW HEADER C1K | НэххК | CCAxxX10K |
| VINDOW HEADER C2 | H9xxT | WCHxxX9T |
| VINDOW HEADER C2K | H9xxTK | WCHxxX9TK |
| VINDOW HEADER C3 | H12xxBT | WCHxxX10BT |
| VINDOW HEADER C3K | H12xxBTK | WCHxxX10BTK |
| VINDOW HEADER C4 | H14xxBT | WCHxxX14BT |
| VINDOW HEADER D1 | H7xxF-4 | N/A |
| VINDOW HEADER D1K VINDOW HEADER D2K | H7xxF-4K H9xxK-1 | N/A |
| VINDOW HEADER D2K | Z-W1 | N/A Z-W1 |
| VINDOW HEADER Z-W1 | Z-W1 Z-W3 | Z-W1 |
| VINDOW HEADER Z-W3 | Z-W3 Z-W3K | Z-W3 Z-W3K |
| VINDOW HEADER Z-W3D | Z-W3R Z-W3D | Z-W3R Z-W3D |
| VINDOW HEADER Z-W4 | Z-W4 | Z-W4 |
| VINDOW HEADER Z-W4K | Z-W4K | Z-W4K |
| | | |
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| | PILASTERS | | |
|--|----------------------|-------------|-------------------|
| Drees General Callout | Nuwood | F | ypon |
| FLUTED PILASTER A1 | PL7xxF | PIL7Xxx | |
| FLUTED PILASTER B1 | PL9xxF | PIL9Xxx | |
| FLUTED PILASTER C1 | PL11xxFM | PIL11Xxx | |
| PANEL PILASTER A2 | PL7xxP | PIL7XxxDP | |
| PANEL PILASTER B2 | PL9xxP | PIL9XxxDP | |
| PANEL PILASTER C2 | PL11xxPM | PIL11XxxDP | 1 |
| PILASTER D1 | M311-9 | PIL10XxxA | |
| PILASTER D2 | M323-9 | N/A | |
| PILASTER Z-E1-PIL | Z-E1-PIL | Z-E1-PIL | |
| PILASTER Z-E2-PIL | Z-E2-PIL | Z-E2-PIL | |
| PILASTER Z-EZ-PIL PILASTER Z-E3-PIL | Z-EZ-PIL Z-E3-PIL | | |
| | | Z-E3-PIL | |
| PILASTER Z-PIL-EXT | Z-PIL-EXT | Z-PIL-EXT | |
| PLAIN PILASTER A3 | PL7xxS | PIL7XxxP | |
| PLAIN PILASTER B3 | PL9xxS | PIL9XxxP | |
| PLAIN PILASTER C3 | PL11xxS | PIL11XxxP | |
| PLINTH D1 | PF10 | ADD "P" TO | END OF PILASTER |
| PLINTH D2 | P14.5 | N/A | |
| | LOUVERS | | |
| Drees General Callout | Nuwood | Fypon | Mid-America |
| | | | |
| CATHEDRAL LOUVER D1 | CLV1224 | CLV12X24 | |
| CATHEDRAL LOUVER D1T | CLV1224TRIM4 | CLV12X24X4F | |
| CATHEDRAL LOUVER D2 | CLV1432 | CLV14X32 | |
| CATHEDRAL LOUVER D2T | CLV1432TRIM4 | CLV14X32X4F | 00 44 1422 |
| CATHEDRAL LOUVER D3 | CLV2232 | CLV22X32 | |
| CATHEDRAL LOUVER D3T | CLV2232TRIM4 | CLV22X32X4F | |
| HALF CIRCLE LOUVER D1 | HRLV32 | HRLV32X16 | |
| HALF CIRCLE LOUVER DIT | HRLV32TRIM4 | HRLV32X4F | |
| | | | |
| HALF CIRCLE LOUVER D2 | HRLV36 | HRLV36X18 | |
| HALF CIRCLE LOUVER D2T | HRLV36TRIM4 | HRLV36X4F | 00 43 2234 |
| OCTAGONAL LOUVER D1 | OLV24 | OLV24 | |
| OCTAGONAL LOUVER D12 | OLV24TRIM4 | OLV24X4F | |
| OVAL LOUVER D1 | OLV2537 | OLV37X25 | |
| OVAL LOUVER D1T | OLV2537TRIM4 | OLV37X25X4F | |
| RECTANGUAR LOUVER D1 | LV1224V | LV12X24 | 00 45 1218 |
| RECTANGUAR LOUVER D1T | LV1224VTRIM4 | LV12X24-4F | 00 45 1218 |
| RECTANGUAR LOUVER D2 | LV1636V | LV16X36 | |
| RECTANGUAR LOUVER D2 | LV1636VTRIM4 | LV16X36-4F | |
| | | | |
| RECTANGUAR LOUVER D3 | LV2436V | LV24X36 | |
| RECTANGUAR LOUVER D3T | LV2436VTRIM4 | LV24X36-4F | |
| RECTANGUAR LOUVER D4 | LV2424V | LV24X24 | |
| RECTANGUAR LOUVER D4T | LV2424VTRIM4 | LV24X24-4F | |
| ROUND LOUVER D1 | RLV18 | RLV18 | |
| ROUND LOUVER D1T | RLV18TRIM4 | RLV18X4F | |
| ROUND LOUVER D2 | RLV22 | RLV22 | |
| ROUND LOUVER D2T | RLV22TRIM4 | RLV22X4F | |
| TRIANGULAR LOUVER D1 | | TRLVxxX36 | 00 47 0x0x |
| | | | |
| | BRACKETS | | |
| Drees General Callout | Nuwood | F | ypon |
| EXTERIOR BRACKET D1 | BR437 | N/A | |
| EXTERIOR BRACKET D2 | DB102 | DTLB6X4X6 | |
| EXTERIOR BRACKET D3 | BR304 (7" WIDE) | BKT24X24X | 7 |
| EXTERIOR BRACKET D4 | BR455 | N/A | • |
| EXTERIOR BRACKET D5 | BR300-1 | BKT12X12X | 6 |
| EXTERIOR BRACKET DS | | | 0 |
| | BR300 | BKT12X12 | า |
| EXTERIOR BRACKET D7 | BR409 | BKT16X18X | 3 |
| EXTERIOR BRACKET D8 | BR413 | DTLB5X5X3 | |
| EXTERIOR BRACKET D9 | TBD | BKT11X20 | |
| EXTERIOR BRACKET D10 | TBD | BKT12X24X | 3 |
| EXTERIOR BRACKET D11 | BR435 | BKT25X27 | |
| EXTERIOR BRACKET D12 | BR404 | BKT16X30X | 4 |
| GABLE BRACKET D1 | TBD | | T R(OR L)PITCH |
| GABLE BRACKET D2 | BR423-x:12 | BKT5X20 | |
| | | | |
| GABLE BRACKET D3 | BR424-x:12 | | UT 2" PROJECTION) |



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Sheet Description:


MOULDED MILLWORK SCHEDULE

LAST REVISED 11/22/17


| | | LAST REVISED 11/22/17 |
|-------------------------|----------------------|---|
| | MOULDINGS | |
| Drees General Callout | Nuwood | Fypon |
| BAND MOULD D1 | M210-16 | MLD612-12 |
| BAND MOULD D2 | M301-16 | MLD220-16 |
| BARGE MOULD D1 | WM210 | WM210 |
| CASE MOULD D1 | M320-16 | MLD226-16 |
| CASE MOULD D2 | N/A | MLD244-12 |
| CROWN MOULD D1 | M404-16 | MLD572-16 |
| DENTIL MOULD D1 | M105-16 | MLD310-16 |
| DENTIL MOULD D2 | M108-8 | MLD353-8 |
| HALF ROUND MOULD D1 | N/A | MLD605-12 |
| PANEL MOULD D1 | M310-8 OR 16 | MLD612-12 |
| PEDIME | NTS / COMBO HEA | ADERS |
| Drees General Callout | Nuwood | Fypon |
| BROW COMBO D1 | BCxx | CSAPxx |
| PEAK PEDIMENT D1 | Pxx-4 (6:12) | PCPxx |
| PEAK PEDIMENT Z-E1-PED | Z-E1-PED | Z-E1-PED |
| PEAKED COMBO D1 | PCxx-4 | CPCPxx |
| RAMS HEAD PEDIMENT D1 | Rxx | RHPxx00 |
| ROUND PEDIMENT D1 | Bxx-4 | PSPxx |
| SUNRISE COMBO D1 | SCxx-4 | CSPxx |
| VICTORIAN PEDIMENT D1 | VPxx | DVPxx w/ SWDHxxXxx |
| 1IW | |)N |
| Drees General Callout | Nuwood | Fypon |
| HALF CIRCLE SUNBURST D1 | SPxxxx | SWDHxxXxx |
| PALLADIAN WINDOW D1 | H9AR10-xx xx" FL/FR | ARxxX10MFLxxx |
| PALLADIAN WINDOW D1K | H9AR10-xxK xx" FL/FR | ARxxX10MFLxxx with K10TM |
| PALLADIAN WINDOW D2 | H9AR10SPxxxx | ARxxX10MFLxxx with |
| | | SWDHxxXxx |
| PALLADIAN WINDOW D2K | H9AR10SPxxxxK | ARxxX10MFLxxx with SWDHxxXxx and K10TM |
| PEAKED CAP HEADER D1 | N/A | CHPCxxX15 |
| PLAIN SEGMENT D1 | SPxxxxP | PSPxx |
| SEGMENT SUNBURST D1 | SPxxxx | SWDHxxXxx |
| | ACCESSORIES | |
| Drees General Callout | Nuwood | Fypon |
| GABLE D1 | PGDx12 | GPA (width X height) |
| KEYSTONE D1 | KY14F-3 | KY14 |
| KEYSTONE D2 | KYHM9F | K9M |
| WREATH D1 | N/A | WAB34 |
| | | |

Sheet No.


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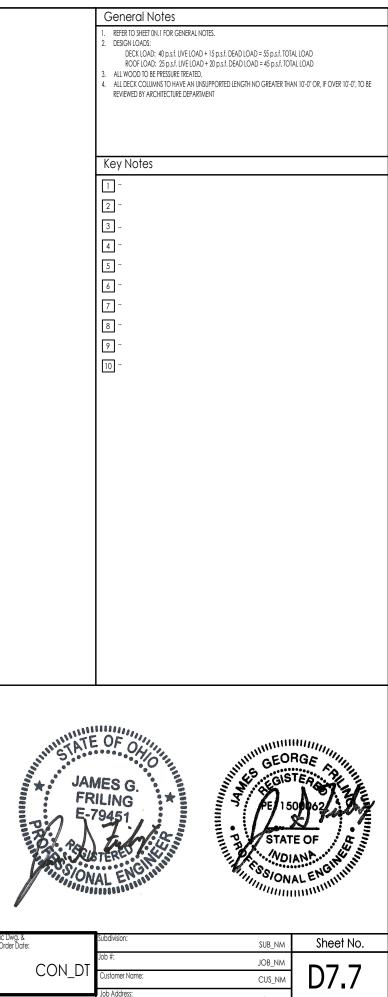

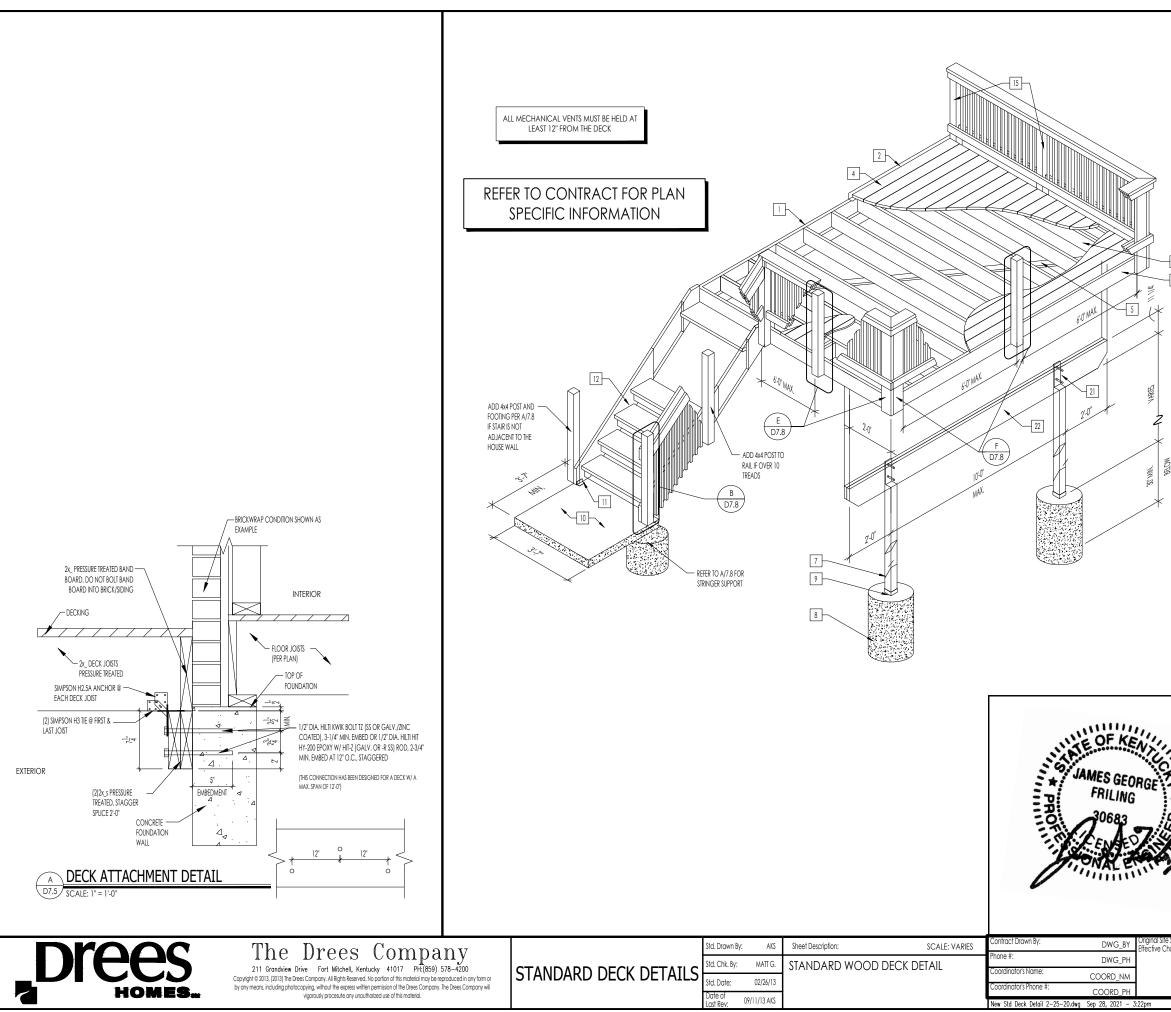
| | General Notes |
|-------------------------------------|--|
| | REFER TO SHEET ON. I FOR GENERAL NOTES. DESIGN LOADS: |
| | DECK LOAD: 40 p.s.f. LIVE LOAD + 15 p.s.f. DEAD LOAD = 55 p.s.f. TOTAL LOAD ROOF LOAD: 25 p.s.f. LIVE LOAD + 20 p.s.f. DEAD LOAD = 45 p.s.f. TOTAL LOAD |
| | 3. ALL WOOD TO BE PRESSURE TREATED. |
| | ALL DECK COLUMNS TO HAVE AN UNSUPPORTED LENGTH NO GREATER THAN 10'-0" OR, IF OVER 10'-0", TO BE REVIEWED BY ARCHITECTURE DEPARTMENT |
| | Key Notes |
| | THIS SIDE OF DECK BUILT AGAINST HOUSE. FOR LEDGER CONNECTION, USE A/D7.5 FOR STANDARD DECK CONNECTION, USE DETAILS SHEET D7.6 FOR BRICK TO GRADE DECK CONNECTION; USE DETAILS SHEET D/7.7 FOR |
| | SIDING TO GRADE DECK CONNECTION 2 FLASHING AS REQUIRED |
| | 3 - |
| | 4 5/4x6 DECKING WITHOUT SPACING |
| | 5 1x4 DIAGONAL BRACING ATTACHED TO THE BOTTOM CHORD OF THE JOIST (NOT FLUSH). |
| | 6 JOIST AND SPACE PER PRINTS |
| 6 | 7 WOOD POST - USE 6x6 POST UP TO 20'-0" IN HEIGHT MAXIMUM. |
| 23 | 8 16" DIAMETER SONOTUBE FOOTING TO FROST, TYP. |
| | 9 USE SIMPSON ABW66Z FOR 6x6 POST |
| | 10 CONCRETE PAD |
| | 2) ANGLE BRACKETS TO PREVENT KICKOUT |
| | U2 WOOD STEPS AS REQUIRED BY GRADE |
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| | 14 5/4 x6 RAIL CAP, GRASPABLE FINGER RECESS AREA SHOULD BE ON BOTH SIDES OF THE PROFILE. THE FINGER RECESS SHALL BEGIN WITHIN A DISTANCE OF 3/4 INCH MEASURED VERTICALLY FROM THE TALLEST PORTION OF THE PROFILE AND ACHIEVE A DEPTH OF AT LEAST 5/16 INCH WITHIN 7/8 INCH BELOW THE WIDEST PORTION OF |
| | THE INVITE THE REQUIRED DEPTH SHALL CONTINUE FOR AT LEAST 30 INCH TO A LEVEL THAT NOT CHESS THAN 1-3/4 INCHES BELOW THE TALLEST PORTION OF THE PROFILE. THE MINIMUM WIDTH OF THE HANDRAIL ABOVE THE |
| ц ц | RECESS SHALL BE 1-1/4 INCHES TO A MAXIMUM OF 2-3/4 INCHES. EDGES SHALL HAVE A MINIMUM RADIUS OF 0.01 INCH. |
| | |
| | 15 PRESSURE TREATED 4x4 POST |
| | 16 - |
| | 2x12STAIR TREAD |
| | 18 ROUTED 2x10 STAIR STRINGER TO ACCEPT STAIR TREADS. |
| | <u>19</u> - |
| | |
| | 21 NOTCH TOP OF POST TO ACCEPT BEAM PER PRINTS - BOLT W/(2) 1/2' THROUGH BOLTS |
| | 22 BEAM PER PRINTS |
| | 23 2x BANDBOARD |
| | 24 |
| | 25 24 MOLEN LED HOTT TO UNDERVISE OF STARK ILED. A TRACT THROUGH END AT STRINGER AND DOTTING |
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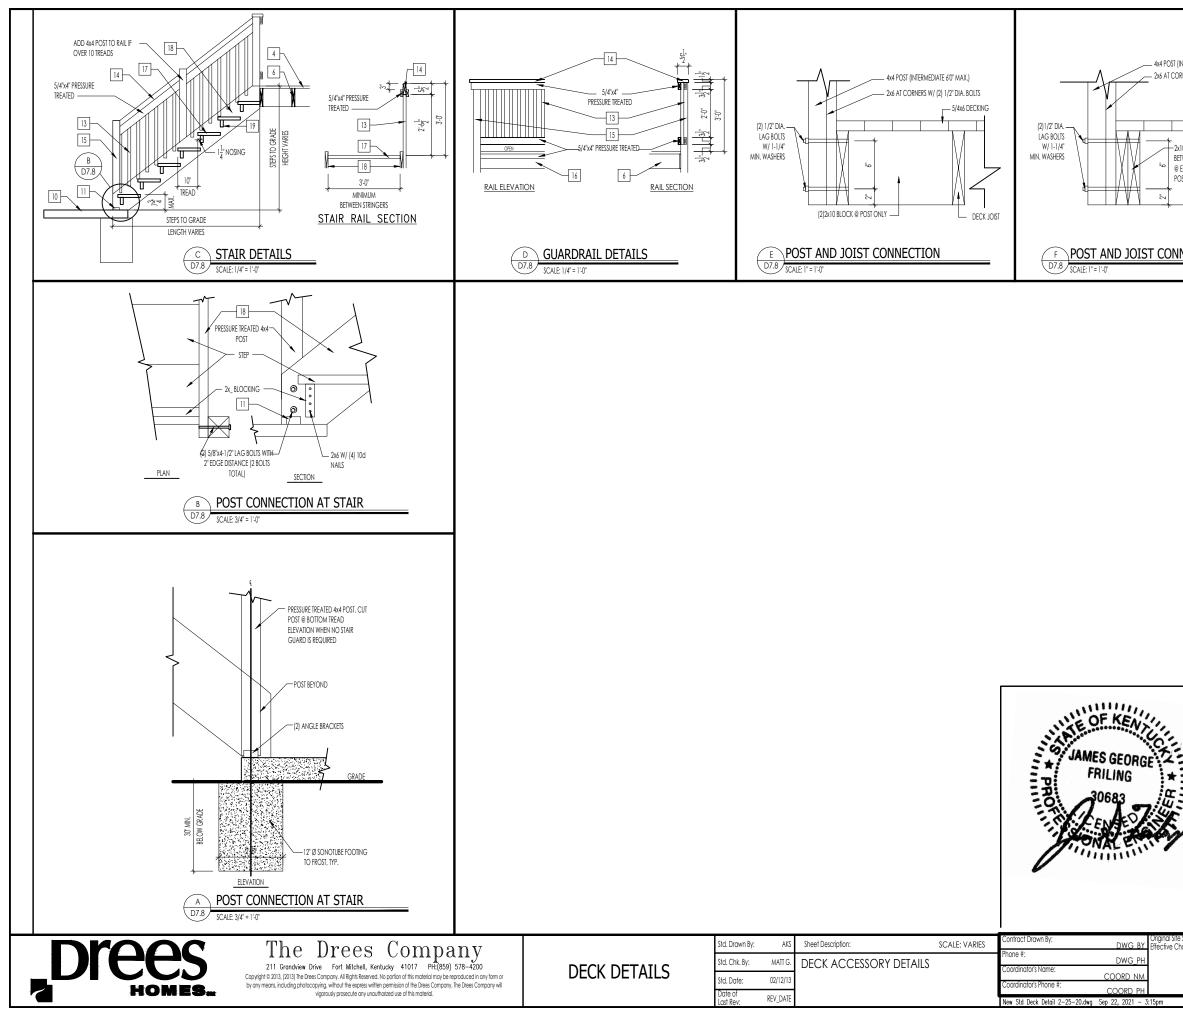


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| Job Address: | JOB_AD | |
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JOB_AD

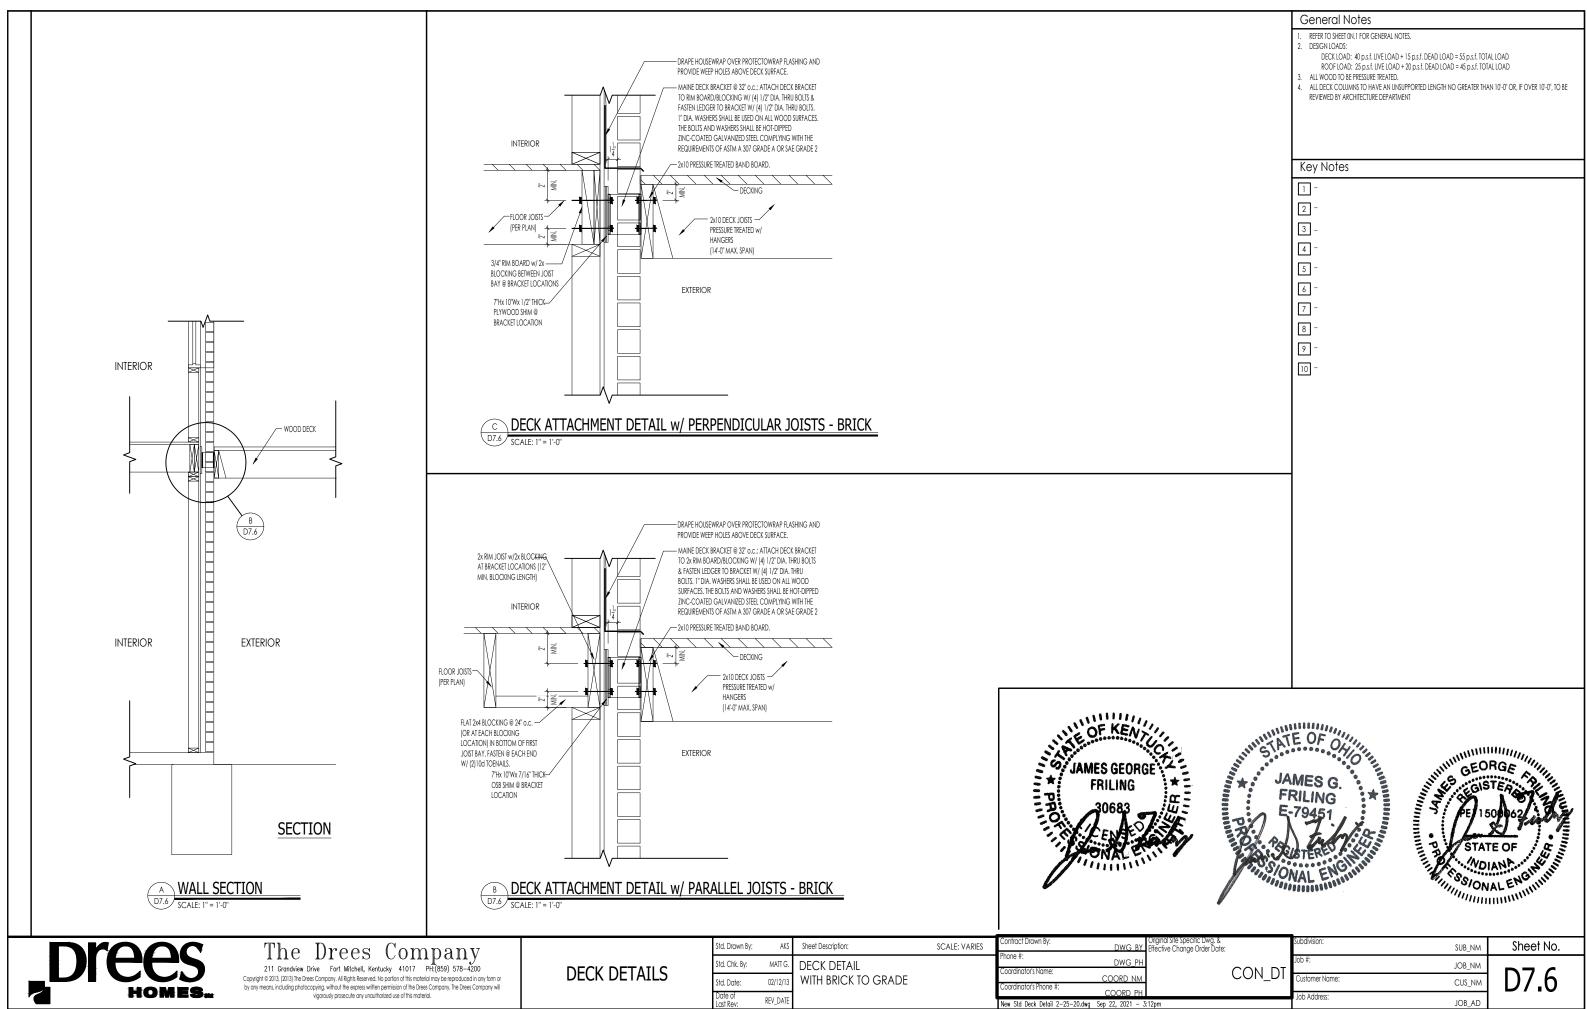

| | General Notes | |
|--------------------------------------|--|---|
| | REFER TO SHEET 0N.1 FOR GENERAL NOTES. DESIGN LOADS: | |
| INTERMEDIATE 6'0' MAX.) | DECK LOAD: 40 p.s.f. LIVE LOAD + 15 p.s.f. DEAD LOAD = 55 p.s.f. TOTA ROOF LOAD: 25 p.s.f. LIVE LOAD + 20 p.s.f. DEAD LOAD = 45 p.s.f. TOTA | |
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| | 5 1x4 DIAGONAL BRACING ATTACHED TO THE BOTTOM CHORD OF THE JOIS | t (NOT FLUSH). |
| | 6 JOIST AND SPACE PER PRINTS | |
| | 7 WOOD POST - USE 6x6 POST UP TO 20'-0" IN HEIGHT MAXIMUM. | |
| | 8 16" DIAMETER SONOTUBE FOOTING TO FROST, TYP. | |
| | 9 USE SIMPSON ABW66Z FOR 6x6 POST | |
| | 10 CONCRETE PAD | |
| | 11 (2) ANGLE BRACKETS TO PREVENT KICKOUT | |
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| | 12 WOOD STEPS AS REQUIRED BY GRADE | |
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| | 14 5/4 x6 RAIL CAP. GRASPABLE FINGER RECESS AREA SHOULD BE ON BOTH S RECESS SHALL BEGIN WITHIN A DISTANCE OF 3/4 INCH MEASURED VERTICA | IDES OF THE PROFILE. THE FINGER ALLY FROM THE TALLEST PORTION OF |
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ORDINANCE NO. 2023-36

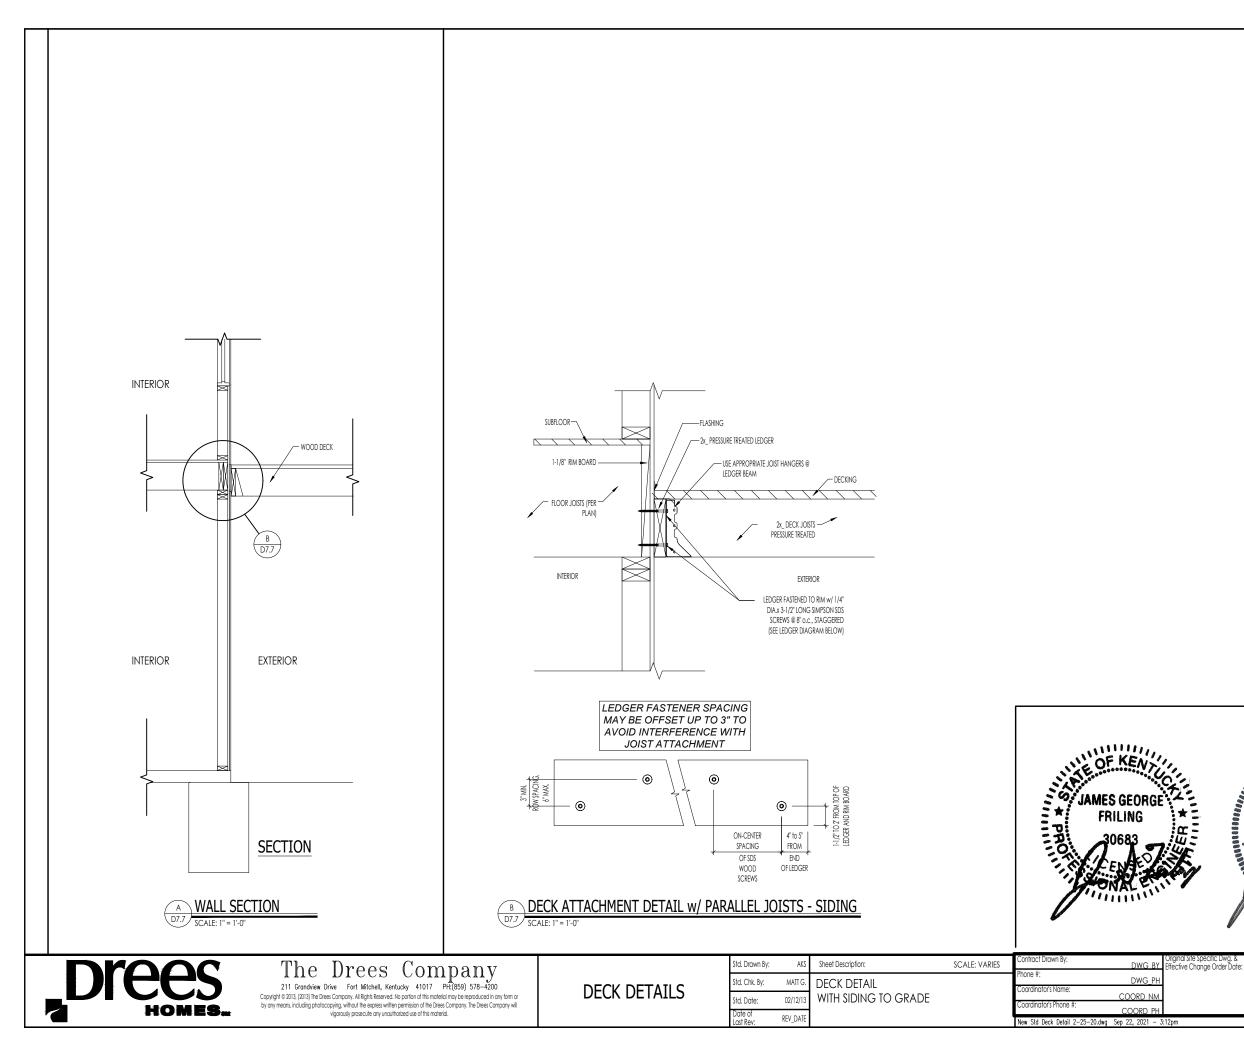INTRODUCED BY: Vice Mayor Weiss

AN ORDINANCE AMENDING CODIFIED ORDINANCE SECTION 1064.05 ENTITLED "STORAGE BEHIND REAR BUILDING LINE" AND DECLARING AN EMERGENCY.

WHEREAS, City Council wishes to enact standards and regulations that are clear and enforceable relating to storage of garbage cans and/or trash/rubbish receptacles;

WHEREAS, City Council wishes to enact regulations relating to storage of garbage cans and/or trash/rubbish receptacles that will improve the health and safety of the community, reduce litter and garbage on city streets, and enhance the aesthetics of neighborhoods; and

WHEREAS, City Council wishes to enact penalties for failure to adhere to its regulations relating to storage of garbage cans and/or trash/rubbish receptacles;

NOW, THEREFORE, BE IT ORDAINED BY THE COUNCIL OF THE CITY OF UNIVERSITY HEIGHTS, COUNTY OF CUYAHOGA, AND STATE OF OHIO, THAT:

<u>Section 1.</u> Council hereby amends Codified Ordinance Section 1064.05 entitled "Storage Behind Rear Building Line", which shall read in its entirety as follows:

1064.05 STORAGE BEHIND REAR BUILDING LINE

Except after sunset on the day before the regularly scheduled garbage and rubbish collection for the premises involved, and the actual time of collection, no person shall deposit, store, cause or allow to be stored on the premises under his or her ownership or control, any ashes, garbage, refuse, rubbish or waste paper, unless such deposit or storage takes place behind the rear building line of the premises.

(a) Garbage cans, trash/rubbish receptacles or any other container for waste (hereafter "Container") may not be stored in front of the rear foundation line of any residence, or in front of the rear foundation line of any building which is parallel with any street line on which the building fronts, except after sundown on the evening immediately preceding the day for refuse collection and for 12 hours immediately following refuse collection by the City.

(b) Empty Containers are not permitted to remain in front of the rear foundation line of any residence or building by the owner, agent, lessee or occupant of that residence or building for a period in excess of 12 hours from the time of collection by the City

(c) No owner, agent, lessee or occupant of any property or any other responsible party shall violate subsections (a) or (b) hereof. If there is a violation, the violation shall be enforced as follows:

- (1) The Housing and Community Development Director, Building Commissioner, Certified Building Official, Service Director or Chief of Police or sworn peace officer are authorized to issue notices and citations to the owner, agent, lessee, occupant or other responsible party of any property maintained in violation of this ordinance.
- (2) The authorized official shall post a notice of violation in a conspicuous location on the property. The notice shall state the time when the notice was issued and shall indicate the nature of the violation. Should another violation occur within 18 months of the original violation, the property owner shall be charged seventy-five dollars (\$75.00).

ORDINANCE 2023-36 | Page 1 of 2

(3) Payment shall be made to the City of University Heights, Housing and Community Development Department, within thirty days of the date of the bill. Any bill that is not paid within thirty days shall be placed on the property taxes of the property owner as a tax lien for collection by the City Finance Director.

(d) Nothing herein shall be construed to limit the authority of the City or its Law Director to undertake any action or to seek any other remedies or sanctions available.

<u>Section 2.</u> Codified Ordinance Section 1064.05 in existence immediately prior to the passage of this ordinance is hereby repealed.

<u>Section 3.</u> It is hereby found and determined that all formal actions of this Council concerning and relating to the passage of this Ordinance were adopted in an open meeting of this Council, and that all deliberations of this Council and of any of its committees that resulted in such formal action, were in meetings open to the public, in compliance with all legal requirements including the requirements of Section 121.22 of the Ohio Revised Code.

<u>Section 4.</u> This Ordinance is declared to be an emergency measure necessary for the preservation of the public peace, safety, health and welfare of the citizens of the City of University Heights, by amending the regulations in Section 1064.05 so that they are clear and enforceable, for the health and safety of the City's residents. It shall therefore become effective upon its passage by the affirmative vote of not less than five (5) members of Council and approval of the Mayor; otherwise it shall become effective at the earliest time allowed by law.

City of University Heights, Ohio

Michael Dylan Brennan, Mayor

Passed:_____

Attest: Kelly M. Thomas, Clerk of Council

Approved as to form:

Luke F. McConville, Law Director

INTRODUCED BY: MAYOR MICHAEL DYLAN BRENNAN

AN ORDINANCE AMENDING CODIFIED ORDINANCE SECTION 1246.01 ENTITLED "GENERAL PROVISIONS" FOR THE PURPOSE OF ELIMINATING THE RESIDENCY REQUIREMENT FOR MEMBERSHIP ON THE ARCHITECTURAL REVIEW BOARD, AND DECLARING AN EMERGENCY

WHEREAS, the City wishes to eliminate the residency requirement for membership on the Architectural Review Board ("ARB") for the purposes of expanding the potential pool of candidates to fill positions on the Board;

WHEREAS, the City has had a vacancy on the Architectural Review Board since January of 2023 and has had no applicants step forward to fill the vacancy;

WHEREAS, by expanding the pool of candidates for the Architectural Review Board, the City will reduce the possibility for conflicts of interest that would cause recusal of members from the same firm that could make reaching a quorum more difficult;

NOW, THEREFORE, BE IT ORDAINED BY THE COUNCIL OF THE CITY OF UNIVERSITY HEIGHTS, OHIO THAT:

<u>Section 1.</u> Council hereby amends Codified Ordinance Section 1246.01 entitled "General Provisions," to read in its entirety as set forth in Exhibit A hereto, a copy of which is attached and which is incorporated herein by reference as if fully rewritten. A complete copy of Exhibit A is also on file with the Clerk of Council.

<u>Section 2.</u> It is hereby found and determined that all formal actions of this Council concerning and relating to the passage of this ordinance were adopted in an open meeting of this Council, and that all deliberations of this Council and any of its committees that resulted in such formal action, were in meetings open to the public, in compliance with all legal requirements.

Section 3. This Ordinance is hereby declared to be an emergency measure necessary for the immediate preservation of the public peace, health and safety of the City and for the further reason that an appointment to fill the current Board vacancy must be made as soon as possible so that ARB may conduct its business with a full slate of members; wherefore, this ordinance shall be in full force and effect from and immediately after its adoption and approval by the Mayor.

CITY OF UNIVERSITY HEIGHTS, OHIO

MICHAEL DYLAN BRENNAN, MAYOR

PASSED:

ATTEST:

KELLY M. THOMAS, CLERK OF COUNCIL

APPROVED AS TO FORM:

LUKE F. MCCONVILLE, LAW DIRECTOR

§ 1246.01 GENERAL PROVISIONS.

(a) <u>Creation, Purpose and Intent.</u> The Architectural Review Board is hereby created to review applications for new or replacement dwelling structures in all residential zoned districts, and to review applications in all other zoning districts when an increase in building square footage or a substantial exterior change is proposed, to:

- (1) Ensure that new development and redevelopment are compatible and harmonious with the existing overall character of the City;
- (2) Strengthen, enhance and improve the existing visual and aesthetic character of the City; and
- (3) Maintain a high design character of community development, and ensure compatibility of new development.

(b) <u>Powers and Duties</u>. The Architectural Review Board shall review plans for new development and alterations to existing development in the following respects:

- (1) The design of the building use of materials, finish grade lines, dimensions, orientation, fenestration and proportions.
- (2) The design of the building in conjunction with site features such as landscaping, parking, and vehicular and pedestrian circulation for all projects to be erected, altered, remodeled or repaired; and
- (3) The design and placement of business identification signs when referred by the Building Commissioner.

In undertaking this review, the Architectural Review Board may promulgate design criteria to guide subsequent phases of development.

(c) <u>Membership and Term</u>.

- (1) The Architectural Review Board shall consist of five registered architects who shall be either (i) residents of the City of University Heights or (ii) registered as an architect in the State of Ohio. If a sufficient number of registered architects are not available, one member may be from another related profession if the person has demonstrated an interest, experience or knowledge in architecture, landscape architecture, urban design or related disciplines. In the event the Building Commissioner is a registered architect, he or she may serve as a voting member of the ARB, even if not a resident of University Heights, provided that the Building Commissioner must be appointed by the Mayor and approved by Council in order to serve in such capacity. The Building Commissioner shall be eligible to participate in discussions whether he or she is a voting member or not.
- (2) One other registered architect meeting the criteria of division (c)(1) hereof shall be designated as an alternate to the ARB and shall review any proposal where a member of the ARB has a conflict of interest.
- (3) All members shall be appointed by the Mayor and approved by Council.
- (4) The term of office shall be for three years, except in the case of appointments made in 2022, in which case the terms shall be staggered so that at least one term expires every three years.
- (5) If there is a vacancy for any reason, a newly appointed person shall complete the unexpired term.

(6) All members of the Architectural Review Board shall be paid \$50.00 per attended meeting. Should one of the members hold a salaried position with the City during his or her appointment, this person shall not be compensated for his or her attendance at these meetings, or for any other related time or service to the ARB.

(d) <u>Action by ARB</u>. The Architectural Review Board shall meet as necessary. Approval of an application submitted to the ARB shall require the affirmative vote of a majority of a quorum. A quorum shall be not less than three members. In the event an application is not approved by the ARB, the ARB shall clearly indicate to the applicant the reasons the application was not approved. When proposals before the ARB are also subject to Planning Commission and/or Board of Zoning Appeals action, the ARB decision shall serve as a recommendation. When action is taken on a proposal that is not subject to the Board of Zoning Appeals or Planning Commission, the decision of the ARB will be final. Any person aggrieved by a final decision of the ARB may appeal to the Board of Zoning Appeals within ten days of the decision.

(e) <u>Interpretive Illustrations for Design Guidelines</u>. The ARB may prepare from time to time or authorize the preparation of illustrations which demonstrate the development and design guidelines in Section 1262.12. Such illustrations may include drawings and/or photographs that depict the guidelines. Any such illustrations shall be considered administrative guidelines which assist in the utilization of the development and design guidelines.

(f) <u>Application</u>. Applicants shall complete a form as prescribed by the Building Commissioner and approved by the Law Director. The application fee shall be one hundred dollars (\$100.00). Drawings, photographs or samples shall be submitted that will property communicate the applicant's proposal. The Building Commissioner may reject an application if he or she determines the documents are inadequate.

(g) <u>Permits</u>. The Building Commissioner may not issue permits for projects subject to ARB action until approved by the ARB. Conditions of approval shall become part of the permit documents.



Ohio Arts Council 30 East Broad Street, 33rd Floor Columbus, Ohio 43215-3414 614-466-2613 oac.ohio.gov For TTY/TDD use Ohio Relay Service 1 -800-750-0750

Grant Number: 2416079 Program: ArtSTART

This agreement, with the objective of promoting and preserving the arts in Ohio, entered into on July 20 2023 by and between the Ohio Arts Council, an agency of the State of Ohio, and hereafter referred to as the "Council," with offices at 30 East Broad Street, 33rd Floor, Columbus, Ohio 43215-3414, and the "Participant" who is listed immediately below:

City of University Heights 2300 Warrensville Center Road University Heights, OHIO 44118-3825

Whereas, the Participant has requested financial assistance for **2023 Fall Fest** and has submitted an application and verified its most recently completed fiscal year with financial statements (as required) to the Council, and

Whereas, the Participant pledges \$4,444.00 as matching funds to qualify for Council assistance, and

Whereas, between 09/01/2023 and 10/31/2023, City of University Heights will present Fall Fest, a one-day celebration that features live music, family activities, interactive arts programming, and local vendors.

Now Therefore, the Council shall pay to the Participant an amount not to exceed the sum of \$4,444.00 subject to the following conditions and covenants:

1. This Agreement is conditioned upon the availability of funds appropriated to the Council or available to it from other sources. This Agreement is subject to the determination by the Ohio Arts Council that sufficient funds have been appropriated by the Ohio General Assembly to the Ohio Arts Council for the purposes of this contract, and to the certification of funds by the Office of Budget and Management, as required by Ohio Revised Code 126.07. If the Ohio Arts Council determines that sufficient funds have not been appropriated for the purposes of this contract, or if the Office of Budget and Management fails to certify the availability of funds, this Agreement or any renewal thereof will terminate on the date that the funding expires without any further obligation by either party.

2. If the Participant's programming is comprised, in whole or in part, of any events such as exhibit or performance, the Participant shall submit to the Council the date, time, and location as soon as known, but no later than two weeks before the event. In order to provide members of the Council Board, appropriate Council committees, and the Council staff with the opportunity to view the arts program supported by the Council, the Participant agrees to admit said individuals upon request.

3. Promptly notify the Council of any changes or problems in the program and of the need for changes to this Agreement. There shall be no variance from this Agreement without prior written approval of the Council. If any such change, substitution, or variance shall occur, the Council shall have the right to reduce its obligation under this Agreement to the extent it judges itself damaged, which judgment shall be conclusive and binding upon the Participant, or the Council may terminate this Agreement and thereafter have no further obligation to the Participant.

4. In order to provide accountability of Council funds, the Council shall reserve the right to conduct program evaluations and financial audits at such times, places, and by such means, and in such manner, as the Council, in its sole discretion, shall determine, and the Participant agrees to, and shall, fully cooperate with the Council and its agents and representatives.

5. The participant may request a partial payment which is 50 percent of the total grant. Participants in need of partial payment must complete a Partial Payment Request confirming that Council funds will be used only for expenses that have been incurred during the grant period. Denial of the request is not a breach of the Agreement or any part of it by Council. The Participant agrees to comply with all terms of the Partial Payment Request.

6. The Participant shall submit a full and certified accounting, summarizing all expenditures, as required on the Council Final Report

Grant Agreement -1360418 2416079 test- City of University Heights

Form. This accounting shall be subject to financial audit and program evaluation by appropriate agencies of the State of Ohio and the United States Government. The Participant will be responsible for the safekeeping and identification of records that corroborate the program financial statements. Said records (sales receipts, invoices, travel claims, pay vouchers, etc.) must be kept in the Participant's files for a period of three (3) years after the completion of the grant period, and be produced and made available to the Council for inspection and reproduction, at the request of the Council.

7. The Council shall process a payment to the Participant for an amount not to exceed that stated above, after completion of the grant period and submission of the appropriate Council Final Report Form, which includes the Participant's financial report detailing expenditures of the Council's grant. The Final Report shall be due thirty (30) days after the completion of the grant period. Council reserves the right to cancel any grant for failure to complete the Final Report within the thirty day period stated above, unless arrangements for an extension have been made with the Council.

8. The Participant shall provide Council with documentation of the activities funded by the Council in this Agreement, including but not limited to, copies of publicity, printed materials, statements of credit, and where appropriate, photographs. These support materials shall be submitted with the Final Report. Where the Participant is awarded funds for an artistic product such as printing of a book or completion of a film or videotape, at least one copy will be made available to Council for viewing purposes to determine whether the terms of this Agreement have been met. Failure to comply with Council's request under this paragraph shall be grounds for the Council in its sole discretion to cancel or rescind this Agreement and any grants or monies due under it.

9. Credit and Publicity Requirements: By signing this Grant Agreement, Participant acknowledges that they have read and agree to the requirements outlined in the Logos and Branding page on the Ohio Arts Council's website (http://oac.ohio.gov/brand). The Participant agrees to all terms and conditions therein and agrees to comply with credit and publicity terms and conditions. Failure to comply with these requirements may jeopardize future funding as the Ohio Arts Council will review and confirm the grantee's past compliance with the credit and publicity requirements prior to approving any additional funding.

10. Grant funds awarded in this Agreement may not be used for brick-and-mortar activities, capital improvements, equipment purchases over \$1,000, hospitality costs, scholarship assistance, or out-of-state travel.

11. The Participant assures Council that direct efforts will be made to involve the community and that said program(s) for which grant funds have been awarded will not be offered for student credit.

12. The Council shall not be responsible or liable for any deficit arising from the Participant's program.

13. In the event the Participant ceases to program arts activities, other than for reasons described below in Article 14, and has previously received financial assistance from the Council, the Participant will reimburse the Council to the full extent of payments made by the Council pursuant to this Agreement.

14. If the Participant is unable to program arts activities during the grant period by virtue of any act or regulation of any public authority, or on account of events such as, but not limited to, war, labor difficulties, strikes, riots, epidemics, interruption of transportation services, acts of God, or any other cause beyond the Participant's control, the Council shall still be obligated to make the payment required herein, to the extent that the Participant has incurred expenses or obligations in connection therewith, which obligations could not otherwise be discharged, due to the occurrence of one of the above circumstances.

15. The Participant shall notify all persons with whom the Participant contracts that the Participant shall be solely responsible for payment and shall not represent that the operation constitutes a joint financial venture with the Council. The Participant hereby agrees to and does assume all risk of claims heretofore or hereafter arising, known, or unknown, from any matters relating to this Agreement, and in addition, agrees to save the State harmless from possible copyright infringements or other claims relating to or growing out of this Agreement or conduct which takes place arising under it. The Council can, at its own option, require the Participant to execute written contracts with those persons, or entities with whom the Participant deals. Council can require all contracts be submitted to it for its review and approval at any time it may deem advisable, and this approval shall apply to all contracts under this clause.

16. The Participant agrees to hold the Council and the State of Ohio harmless from any claims of any kind for injuries or damages which result from the making of any arrangement for said arts programs or in the performance of said program.

17. No person shall be excluded from participation in, denied the benefits of, or otherwise be subjected to discrimination under any program, activity, or service on the basis of race, color, religion, sex, national origin, disability, ancestry, or age. The Participant further agrees not to discriminate against any employee or applicant for employment to be hired in the performance of this Agreement with respect to hire, tenure, terms, conditions, or privileges of employment, or any matter directly or indirectly related to employment because of race, color, religion, sex, national origin, disability, ancestry, or age.

Grant Agreement -1360418 2416079 test- City of University Heights

Participant

18. The Participant herewith assures the Council that (1) all professional performers and related or supporting professional personnel employed on projects or productions which are financed under this Agreement will be paid, without subsequent deduction or rebate on any account, not less than the minimum compensation as determined by the Secretary of Labor to be the prevailing minimum compensation for persons employed in similar activities; (2) no part of any project or production which is financed under this Agreement will be performed or engaged in under working conditions which are unsanitary or hazardous or dangerous to the health and safety of the persons engaged in such project or production. Compliance with the safety and sanitary laws of the State of Ohio shall be prirna facie evidence of compliance. The Participant also agrees to comply with, and not to violate, other laws, state or federal, including those covering health, safety and welfare, but without limitation thereto.

19. The Participant shall not assign this Agreement or any part thereof without the written consent of the Council.

20. The Participant agrees that each of the covenants of the Council contained herein is dependent upon the fulfillment of all the conditions and covenants of the Participant contained herein.

21. If any provision of this Agreement should be held invalid by a Court of the State of Ohio, all other provisions shall nevertheless be in effect and binding upon the parties.

22. This Agreement, including agreements incorporated by reference, is to be governed by the laws of the State of Ohio, and venue shall be proper in Franklin County, Ohio, in the Courts of the State of Ohio.

23. The acceptance of the terms of this Agreement has been authorized by the governing body of the Participant and the undersigned representative has been authorized to act for the Participant in the administration of this Agreement.

In witness hereof, the parties affix their signatures to this Agreement executed in triplicate on the day and year first above mentioned.

State of Ohio - Ohio Arts Council

By: Donna &. Collins

Donna S. Collins Executive Director By: Title: Print Name: EIN:

*To be signed by the Chief Administrative Officer. This must be a person authorized to execute binding contracts with other entities. This Grant Agreement should not be signed by the Project Director if he/she does not have the authority to sign legal documents for the organization.

ADDENDUM to OHIO ARTS COUNCIL AGREEMENT

The following clause replaces Clauses 15 & 16 of the Grant Agreement:

"It is understood that the, the Participant herein, is a state-supported institution of higher education and is not an agent of the Ohio Arts Council. The planning of this arts project, and conduct of and the administration of this grant is the responsibility of this Participant, to the extent permitted by law. The Participant hereby assumes risks for claims arising from matters relating to this arts project, and, to the extent permitted by law, agrees to hold the Arts Council harmless from claims for bodily injury, property damage, false arrest, detention, or imprisonment or malicious prosecution, libel, slander, defamation or violation of the right of privacy, wrongful entry or eviction, or other invasion of the right of private occupancy, which results from the making of any arrangement for said arts project, or in the performance of said project, including use of video or film, when the Participant will be responsible for any copyright infringements, and for violation of constitutional and statutory rights under the United States and the State of Ohio Constitutions and statutes."

Final Score



Starfish Computer Phone: 440-808-0468

Fax: 440-808-0470 24831 Lorain Road North Olmsted, OH 44070
 Quote

 No.:
 13348

 Date:
 7/27/2023

| Prepared for: | Prepared by: Patrick Hanrahan |
|----------------------------------|-------------------------------|
| Michael D Brennan (216) 932-7800 | Account No.: 12849 |
| City of University Heights | Phone: (216) 932-7800 |
| 2300 Warrensville Center Road | |
| University Hts., Ohio 44118 | |
| | |

| Quantity | Description | UOM | Sell | Total |
|--------------|--|----------------------|----------------------|------------|
| | Emergency Support and Service through 8/31/2023 | | | |
| | *Quantity of 1 is for month of August | | | |
| | Emergency Support and Service | | | |
| 1.00 | 20-Hour Block of AdHoc Network Support Services | HR | \$3,100.00 | \$3,100.00 |
| | Spam Filter | | | |
| 1.00 | Spam Filter Monthly Services | EA | \$270.00 | \$270.00 |
| | Server, Desktop Patching, Monitoring and Antivirus | | | |
| 1.00 | Server, Desktop Patching, Monitoring and Antivirus for 35 Desktops - Monthly Service | EA | \$780.00 | \$780.00 |
| | Loaner Switch and Server | | | |
| 1.00 | Starfish Computer Loaner Switch and Server Montly Utilization | EA | \$300.00 | \$300.00 |
| | Backup/Disaster Recovery - Device is Property of Starfish (| Computer Corporation | | |
| 1.00 | Backup Disaster Recovery Monthly Service | EA | \$1,100.00 | \$1,100.00 |
| | Bare Metal Restore Advanced File Level Restore Inverse Chain Technology Instant On-Site Virtualization Instant Off-site Virtualization Screenshot Backup Verification Message Level Exchange Recovery CAPACITY Storage Capacity 6000GB (3000GB Usable) CLOUD Capacity 1 Year Data Retention Dual Bi-Coastal US Based SAS70 Rated Data Centers | | | |
| | | | Your Price: | \$5,550.00 |
| | | | Total: | \$5,550.00 |
| Prices are f | firm until 8/17/2023 Terms: | | | |
| Prepared | by: Patrick Hanrahan, phanrahan@starfishcomp | uter.com | Date: 7/27/20 | 023 |
| Accepted | by: | | Date : | |

| | Quote |
|-------|-----------|
| No.: | 13348 |
| Date: | 7/27/2023 |

Disclaimer

Prices are subject to change, error and availability. Prices do not include shipping and handling, if any. Return Policy: Returned parts will be charged a 20% restocking fee. Returns must be made within in 30 days of our order date. Special order parts are non-returnable.

Please fax signed quote to 440-808-0470 or email to sales@starfishcomputer.com so that your order can be placed. Thank you for your business.

2023- 2024 NFPA 1582 Firefighter Occupational Medical Examinations

Period of Performance: September 30, 2023 - December 31, 2024

<u>Purpose</u>: Provide One (1) NFPA 1582 compliant occupational medical exams for up to 35 employees during the period of performance.

Location of Services to be provided and completed: Cuyahoga County

Exams that shall be completed in physical:

- Chest X-Ray, 2V (baseline/every 5 years)
- Physical Exam
- OSHA Respirator Questionnaire Review
- Occupational and Medical History Review
- Pulmonary Function Test (spirometry)
- Electrocardiogram (EKG) with Interpretation
- Audiogram
- Snellen Distant/Rosenbaum Near Vision
- Prostate Specific Antigen (PSA) Screening
- CBC with Differential/Platelet
- Comprehensive Metabolic Panel (CMP) Includes lipids and liver function
- Urinalysis
- Hepatitis- B Antibody Test (if immunized)
- TB Skin Testing
- Fecal Occult Blood Testing
- Cardiac Stress Testing
- Calcium Scoring Test (40 years and older)
- Skin Cancer
 - o Comprehensive inspection of skin included in physical exam
 - Any suspicious lesions shall be referred for dermatological assessment
- Testicular Cancer
 - o Baseline examination included in physical exam
- Prostate Cancer
 - PSA Testing offered to all male FF at age 50 and annually thereafter
 - PSA Testing offered to all male FF at age 40 and annually thereafter with a family history or are of African American heritage
 - Digital Rectal Exam can be performed if a PSA is obtained
- Colorectal Cancer
 - Fecal Occult Blood testing is recommended for all FF at age 40 and annually thereafter
 - Recommend sigmoidoscopy or colonoscopy beginning at age 50 and with any positive fecal occult blood test
- Bladder Cancer
 - o Urinalysis recommended for all FF to evaluate for blood
 - Referral to urology if positive
- Oral Cancer
 - Examination of the mouth and throat is included in physical exam
- Thyroid Cancer
 - Thyroid palpation for nodules is included in the physical exam



Bricker Graydon LLP 1350 Euclid Avenue Suite 650 Cleveland, OH 44115 216.523.5405 Office www.brickergraydon.com Catherine Swartz Partner 216.523.5465 Direct Phone cswartz@brickergraydon.com

July 13, 2023

VIA EMAIL

Michael Dylan Brennan, Mayor City of University Heights 2300 Warrensville Center Road University Heights, Ohio 44118-3895

Re: Bankruptcy Counsel Services related to University Square Real Estate Holdings LLC, Case No. 23-12301, U.S. Bankruptcy Court, N.D. Ohio ("University Square")

Dear Mayor Brennan:

Thank you for asking Bricker Graydon LLP (the "Firm" or "Bricker Graydon") to serve as your counsel in the matter described below. This letter will confirm the engagement of our Firm and will describe the scope and terms on which we will provide legal services to you.

The Client. City of University Heights, Ohio] (the "Client") will be our client in this engagement.

<u>Scope of Engagement</u>. The Firm is being engaged to represent the Client's interests related to the bankruptcy proceeding of University Square (the "Matter").

In addition to the Matter described in the preceding paragraph, upon your request and only upon our agreement in writing, our representation may extend to other matters. The terms of this letter will apply to such other matters, unless otherwise agreed in writing. It is also understood that the Client is not relying upon us for business, investment, or accounting advice or decisions, nor to investigate the character or credit of any other persons or parties in this matter.

Unless otherwise agreed, our engagement does not include providing any advice or legal services relating to federal or state securities laws, including appearing or practicing before the U.S. Securities and Exchange Commission (the "SEC") or your disclosure obligations under such laws, and we agree that you will not, without our prior written consent, include documents we provide to you in filings with federal or state securities regulators, including the SEC.



<u>Compensation</u>. We customarily charge an hourly fee for legal services, which currently range from \$250 to \$700, depending on the attorney's experience and expertise. Our current paralegal rates range from \$175 to 325 per hour. The hourly rates of our professionals are periodically reviewed and adjusted to reflect the current cost and expertise of delivering comparable legal services. For the Matter, we will provide the Client a 15% discount on hourly rates, with rates through December 31, 2023 for the bankruptcy team as follows:

| Attorney | Standard Rate | Discount Rate |
|-------------------|---------------|---------------|
| Susan Argo | \$600 | \$510 |
| Mike Debbeler | \$700 | \$595 |
| Jeffrey Hendricks | \$525 | \$445 |
| Jeff Pfirrman | \$400 | \$340 |
| Justin Ristau | \$515 | \$435 |
| Sebastian West | \$275 | \$235 |

The fees and costs relating to this matter are not predictable. Accordingly, we have made no commitment to you concerning the maximum fees and costs that will be necessary to resolve or complete this matter. It is expressly understood that payment of the Firm's fees and costs is in no way contingent upon the ultimate outcome of the Matter.

Because of the potential for unpredictable and unforeseen circumstances, we normally cannot quote a precise fee total for the completion of the Matter. If requested, we will endeavor to estimate the total fee where the nature of the Matter allows us to do so. Any estimate would be provided with the clear understanding that it is not a maximum or a fixed-fee quotation; that the cost will likely be more or less than the estimated amount.

Disbursements and Third Party Expenses. In addition to our hourly fees for professional services, you will also be charged for miscellaneous services and cash disbursements incurred on your behalf. These services and expenses include such items as document reproduction, charges for the management and storage of electronic data related to your matter, extraordinary postage, certain staff overtime where justified, on-line research services, and necessary travel expenses (including transportation, lodging, meals, and other related expenses).

Depending on the circumstances, you may also be asked to advance funds to reimburse the Firm for payments made or to be made your behalf, or to pay a third-party directly. These disbursements include items such as regulatory filing fees, special messengers, express deliveries, outside document management and copying services, service of process and court fees, stenographer and videographer fees, expert witness fees, and local or special counsel fees. All such expenses are your responsibility.

<u>Invoices and Payments</u>. Our invoices are typically sent on a monthly basis. If charges incurred in any month are nominal, however, billing may be deferred until the next month. We offer a variety of invoice formats to summarize the services performed, the fees, and related disbursements in a manner that you prefer.

Our invoices are payable upon receipt. We include a carrying charge of 1.5% per month on outstanding balances for invoices remaining unpaid past 45 days from the invoice date. If the delinquency continues and satisfactory payment arrangements are not made, we reserve the right, subject to any necessary tribunal approval, to withdraw from the representation and may pursue collection of your

July 13, 2023 Page 3



account. In the event of any collection action, you agree to pay the costs incurred to collect the balance; including court costs, filing fees, and reasonable attorney's fees.

Professional Responsibility and Conflicts of Interest. The conduct of attorneys and law firms are governed by the Rules of Professional Conduct (the "Rules of Conduct"). They include rules relating to actual or potential conflicts of interest. At the outset of this representation, and for each subsequent engagement, we undertake to identify potential and actual conflicts between your interests and those of others whom we currently represent or have previously represented, based upon the facts as we know them at the time of each engagement. It is always possible that during the course of our relationship, new facts arise which, under the Rules of Conduct, could require us to withdraw from further representation of you, or seek specific consent from you and another current or former client in order to continue representing you. If a conflict situation arises, we will discuss it with you and take appropriate steps to resolve the conflict or other problems, if possible. If you perceive an actual or potential conflict, please promptly contact the undersigned.

<u>Advance Consent to Conflicts</u>. Bricker Graydon represents many other businesses and individuals. It is possible that during the period of this engagement, we may also represent other clients in matters substantially unrelated to this representation, where your respective interests are adverse.

For example:

- If you have a lending relationship with a Bricker Graydon client, we may represent the other client in a substantially unrelated matter in which your interests are adverse, including an unrelated matter arising out of that lending relationship.
- If you have an employment relationship with a Bricker Graydon client, we may represent the other client in a substantially unrelated matter where your interests are adverse, including an unrelated matter arising out of that employment relationship.
- If you have a business relationship with a Bricker Graydon client, we may represent the other client in a substantially unrelated matter where your interests are adverse, including an unrelated matter arising out of that business relationship.

You agree that our representation of you concerning the Matter will not disqualify our Firm from representing other clients in matters, including litigation, that are substantially unrelated to the Matter. You consent to waive any conflict of interest as to those other, substantially unrelated representations. Bricker Graydon agrees, per the applicable Rules of Conduct, not to divulge any confidential or nonpublic information about you that we acquire as a result of our work on the Matter, or to use any such information to your material disadvantage in connection with any substantially unrelated matter in which we represent a party adverse to you.

In addition to legal work the Firm provides to clients, certain attorneys associated with the Firm also provide government relations services to various trade associations and other clients of the Firm ("Government Relations Services"). The Government Relations Services may include, but are not limited to, advocating certain positions on behalf of a client before state legislatures and before various federal, state, and local legislative or regulatory bodies or officials. Such services may include, but are not limited to seeking the enactment, repeal, or amendment of various laws, regulations or ordinances. In connection with the Government Relations Services we provide, we may be engaged to advocate a position on issues that are adverse to the Client's interests.



By executing this engagement letter, the Client is acknowledging that the Client has not retained the Firm to provide Government Relations Services, and that our work for the Client in this Matter will not disqualify the Firm from providing Government Relations Services to other clients, even when the interests of those other clients are adverse to the Client's interests. To the extent such Government Relations Services present an actual or prospective conflict of interest, by executing this engagement letter, the Client agrees to waive the right to disqualify the Firm from providing Government Relations Services to other clients.

<u>Client Information and Communications</u>. So that the Firm's attorneys can fully represent the interests of the Client, it is important that counsel be provided all relevant information concerning the Matter. The Client agrees to timely provide full and complete information requested by counsel in regard to the Matter. The Rules of Conduct provide that in the event the Firm and counsel are not able to adequately represent the interests of the Client as a result of incorrect or insufficient information provided by the Client, the Firm and counsel may terminate the representation in this Matter, subject to any approval required by a court or other authority.

To facilitate communications between the Client and the Firm, we understand that you shall be the point of contact of the Client and that the Firm is to take direction from this person. If there comes a time when the Firm receives conflicting direction from individuals within the Client, such that the Firm can no longer adequately represent the interests of the Client, the Firm may terminate the representation in this Matter, subject to any approval required by a court or other authority.

Internal Consultation with Counsel to the Firm. From time to time, lawyers or others in the Firm will consult with Bricker Graydon lawyers designated as General Counsel and Associate General Counsel to the Firm ("Firm Counsel"). Such consultations with Firm Counsel can touch on ethical and other professional-conduct issues, issues involving potential claims against the Firm that arise in connection with the Firm's representation of a client, and any dispute or potential dispute between you and the Firm. As a condition of the Firm's representation, you agree that any such consultations with the Firm's Counsel are protected from disclosure, including disclosure to you, by the attorney-client privilege, to the extent permitted by law.

<u>Litigation Matters – Litigation Holds</u>. If our representation in the Matter requires the production of information to another party, whether or not that party is adverse, applicable laws and rules likely require the Firm and the Client to preserve information. Any failure to do so may result in severe financial and procedural consequences. The duty to preserve is generally called a "Litigation Hold." A Litigation Hold requires preservation of both hard-copy and electronically stored information ("ESI"). It applies to information that exists at the time of the engagement as well as that which is created later.

By signing this letter, the Client agrees and acknowledges the Client's duty to preserve all information, including ESI, relating to the Matter, regardless of where it is located or what form it is in, until otherwise notified. That means all records, communications, and data. For example, memoranda, letters, spreadsheets, databases in your possession or under the Client's control, calendars, cellular and landline phone data and logs, electronic storage devices, computer drives, emails (including attachments), voice mails, instant messages, audio, video, CD's, charts, handwritten notes, drafts, files, backups, and other materials. This applies to your entire organization and will almost certainly require IT assistance to preserve, or "hold," the information properly. You acknowledge that you understand Litigation Hold duties.

Resolving Disagreements. We hope that no disagreements ever arise concerning any aspect of our professional relationship. If there is a dispute concerning our fees, services, or relationship, we

July 13, 2023 Page 5



encourage prompt conversations with the attorney you are working with to resolve any disagreement. If the issue is not resolved satisfactorily, we urge you to discuss your concerns with either Firm Counsel, Quintin Lindsmith (direct dial: 614-227-8802) or Stephen Smith (direct dial: 859-578-3070).

<u>Conclusion of Representation</u>. Either party may terminate the engagement before the Matter is concluded, at any time and for any reason, by written notice. The Firm's right to terminate the engagement is subject to the applicable Rules of Conduct. Upon your authorization, we will provide the "Client File" to successor counsel selected by you. Client Files include such things as third-party communications, communications with counsel, transactional documents, documents received from other parties, documents received from the Client, public filings, and the like. Client Files do not include Firm Files, described below. If permission to withdraw is required by a court or other authority, you agree to cooperate with such application for withdrawal and to engage successor counsel to represent you.

Client Files will also be provided to the Client upon written request, although such request must be made within five years of termination. We reserve the right to securely destroy or dispose of the Client Files five years after the termination of our representation, unless earlier notice is provided to you.

The Firm's files pertaining to the Matter will be retained by the Firm after termination. These "Firm Files" include such things as Firm administrative records, time and expense reports, personnel and staffing materials, and credit and accounting records; and internal lawyers' work product such as drafts, notes, internal memoranda, and legal and factual research, including investigative reports, prepared by or for the internal use of lawyers. For various reasons, including the minimization of unnecessary storage expenses, we reserve the right to destroy or otherwise dispose of any such Firm Files within a reasonable time after the termination of the engagement.

Following termination of our services, we may ask if you desire your papers and property returned to you ("Client Property"). If you do not respond requesting the return of your papers and property, you agree we may, upon reasonable notice to you, dispose of such Client Property.

After completion of the Matter, changes in the law may occur, and those changes may impact your future rights and liabilities. Unless you engage us after completion of the Matter to provide additional advice, the Firm will have no continuing obligation to advise you with respect to future legal developments.

Unless previously terminated, Bricker Graydon's representation of the Client will terminate upon the earlier of a written confirmation of completion, or sending you our final statement for services rendered in the Matter.

<u>Conclusion</u>. If the foregoing is agreeable, please sign the Acceptance and Agreement below. If we are required to begin providing legal services before you sign below, you are deemed to have accepted the terms of engagement as outlined in this letter.

July 13, 2023 Page 6



Thank you again for selecting us to be your counsel. We look forward to working with you. If you have any questions regarding the foregoing or would like to discuss, please do not hesitate to give me a call.

Very truly yours,

Catherine Anatz

Accepted and Approved:

CITY OF UNIVERSITY HEIGHTS, OHIO

By:

Michael Dylan Brennan, Mayor

Date: July __, 2023